ASHLAND COUNTY COURTHOUSE HVAC SYSTEM UPGRADES

142 WEST 2ND STREET ASHLAND, OH 44805



SITE PLAN

NOT TO SCALE



ISSUED FOR BIDDING: JANUARY 22, 2021

PROJECT SPECIFIC SCOPE &

- 1. THE BASE SCOPE OF THIS PROJECT INCLUDES THE ADDITION OF FOUR (4) DUCTLESS VARIABLE REFRIGERANT VOLUME (VRV) SYSTEMS, THREE (3) DEDICATED OUTDOOR AIR SYSTEMS (DOAS) AND REPLACEMENT OF ONE (1) PACKAGED ROOFTOP UNIT AT THE ASHLAND COUNTY COURTHOUSE. A SINGLE PRIME CONTRACT WILL BE EXECUTED WITH THE WINNING MECHANICAL CONTRACTOR AND ALL OTHER WORK WILL BE AS PERFORMED AS A SUBCONTRACTOR TO THE WINNING BIDDER. WORK INCLUDES, BUT IS NOT LIMITED TO INSTALLATION OF NEW EQUIPMENT, REFRIGERANT & CONDENSATE PIPING, DUCTWORK, AIR DEVICES, LINE AND LOW VOLTAGE ELECTRICAL AND A NEW BUILDING CONTROL SYSTEM.
- PERMITS AND PLAN REVIEW: DRAWINGS WILL BE SUBMITTED TO THE CITY OF ASHLAND BUILDING DEPARTMENT BY ENGINEER PRIOR TO PROJECT KICK-OFF. THIS CONTRACTOR IS RESPONSIBLE FOR SECURING AND PAYING FOR ALL SUBSEQUENT FEES, PERMITS AND INSPECTIONS.
- **BUILDING AUTOMATION CONTRACTOR:** 1. AS PART OF THIS PROJECT, THIS CONTRACTOR SHALL PROVIDE INTEGRATION OF ALL NEW EQUIPMENT AND THE EXISTING BOILER PLANT INTO THE COUNTY'S EXISTING SUPERVISORY OPEN ARCHITECTURE CONTROL SYSTEM. CONTACT PHILIP CHIARAPPA AT CONTROL CONCEPTS OF OHIO (330-958-1416, PHILIPC@CONTROLSOHIO.COM) FOR MORE INFORMATION.
- ASHLAND COUNTY PERSONNEL WILL REMOVE FROM SERVICE, DEMOLISH AND DISPOSE OF ANY EXISTING HVAC EQUIPMENT, PIPING, WIRING, ELECTRICAL AS DEEMED NECESSARY PRIOR TO WORK COMMENCING. ADDITIONALLY, COUNTY PERSONNEL WILL REMOVE AND REPLACE ALL ACOUSTICAL CEILING TILES AND GRID AGREED UPON DURING THE PRE-CONSTRUCTION MEETING AS BEING NECESSARY FOR WORK TO BE COMPLETED.
- . ACCESS TO THE SITE WILL BE GIVEN DURING NORMAL WORKING HOURS, MONDAY THROUGH FRIDAY 7 A.M TO 5 P.M. AND SHALL BE COORDINATED A MINIMUM OF 24 HOURS IN ADVANCE.
- 2. CORE/HAMMER DRILLING REQUIRED FOR PIPE AND CONDUIT PENETRATIONS MAY BE POSSIBLE DURING NORMAL WORKING HOURS, HOWEVER MUST BE COORDINATED WITH COUNTY PERSONNEL IN THE EVENT THE NOISE CREATED BY THESE ACTIVITIES WILL BE DISRUPTIVE TO NORMAL COUNTY BUSINESS.
- 3. THE JOB SITE IS A TOBACCO/SMOKE FREE FACILITY (INCLUDING E-CIGARETTES). ANY EMPLOYEE OR SUBCONTACTOR FOUND TO BE USING THESE PRODUCTS ON SITE WILL BE ASKED TO ABSTAIN FROM THESE ACTIVITIES AND A SECOND OFFENSE WILL LEAD TO REMOVAL FROM

- 4. ALL WORK TO BE COORDINATED WITH REPRESENTATIVE OF ASHLAND COUNTY TO ENSURE THE
- 5. THE PICKUP, DELIVERY AND/OR STORAGE OF NEW AND DEMOLISHED EQUIPMENT AND MATERIALS ON THE EXTERIOR OF THE BUILDING IS TO BE KEPT TO AN ABSOLUTE MINIMUM AS A SAFETY PRECAUTION.
- 6. ON-SITE RESTROOM FACILITIES ARE AVAILABLE FOR USE.
- 7. FIELD PERSONNEL WILL BE UNDER VIDEO SURVEILLANCE AT ALL TIMES WHILE ON SITE.
- 8. ALL HOT WORK WILL NEED TO BE COORDINATED WITH ASHLAND COUNTY MAINTENANCE TO ENSURE BUILDING SECURITY/FIRE SYSTEMS ARE DISARMED APPROPRIATELY.
- 9. CONTRACTORS WILL BE REQUIRED TO COMPLY WITH ALL APPLICABLE COVID-19 REQUIREMENTS SET FORTH BY ASHLAND COUNTY REPRESENTATIVES AT THE KICKOFF MEETING FOR THE

SUBMITTALS AND SHOP DRAWINGS:

- . WITHIN 15 WORKING DAYS OF AWARD OF CONTRACT, THIS CONTRACTOR SHALL SUBMIT FOR REVIEW BY THE ENGINEER, COPIES OF MANUFACTURER'S DRAWINGS, CUT SHEETS, AND APPLICATION SPECIFIC PERFORMANCE DATA RELEVANT TO THE PROJECT. THIS REQUIREMENT PERTAINS TO ALL EQUIPMENT AND SYSTEM COMPONENTS INCLUDING VRV UNITS, INDOOR UNITS, AIR HANDLERS, DAMPERS, LOUVERS, AIR DEVICES, HVAC PIPING & INSULATION, HVAC WIRING, SPECIALTIES, ELECTRICAL PANELS, BREAKERS, CONTROLS AND SEQUENCES OF
- . WITHIN 15 WORKING DAYS OF AWARD OF CONTRACT, THIS CONTRACTOR SHALL SUBMIT FOR REVIEW BY THE ENGINEER AND ASHLAND COUNTY A DETAILED ANTICIPATED SCHEDULE FOR PROJECT COMPLETION. AT A MINIMUM, PROJECT SCHEDULE TO INCLUDE ALL WORK DETAILED IN THESE DRAWINGS, EQUIPMENT LEAD TIMES, CRITICAL PATH ITEMS AND SUBCONTRACTOR SCHEDULES.
- 3. PRIOR TO INSTALLATION, THIS CONTRACTOR MUST PROVIDE DETAILED SHOP DRAWINGS FOR REVIEW BY THE ENGINEER/MANUFACTURER FOR ALL REFRIGERANT PIPING AND MANIFOLDS. THESE DRAWINGS SHALL INCLUDE SIZING, DIMENSIONS, FITTINGS, SUPPORTS, ELEVATIONS, TOTAL PIPE LENGTHS AND ANY OTHER APPLICABLE INFORMATION DEEMED RELEVANT TO THE
- 4. ONCE FINAL VRV SYSTEM PIPING LAYOUTS AND ACTUAL REFRIGERANT VOLUMES ARE DETERMINED, THIS CONTRACTOR SHALL WORK WITH THE COUNTY, AHJ AND ENGINEER OF RECORD TO CONFIRM COMPLIANCE WITH ASHRAE STANDARDS 15 & 34 IN REGARDS TO THE REQUIRED CONCENTRATION LIMITS OF R-410A WITH RESPECT TO THE SMALLEST OCCUPIED SPACE CONTAINING A COMPONENT OF THE VRV SYSTEM.

	Sheet List Table
Sheet Number	Sheet Title
C1.0	COVER PAGE
M1.0	LOWER LEVEL HVAC NEW WORK PLAN
M1.1	1ST FLOOR HVAC NEW WORK PLAN
M1.2	2ND FLOOR HVAC NEW WORK PLAN
M1.3	ROOF HVAC NEW WORK PLAN
M3.0	HVAC EQUIPMENT SCHEDULES 1
M3.1	HVAC EQUIPMENT SCHEDULES 2
M4.0	VRV PIPING SCHEMATICS
E1.0	LOWER LEVEL ELECTRICAL NEW WORK
E1.1	1ST FLOOR ELECTRICAL NEW WORK
E1.2	2ND FLOOR ELECTRICAL NEW WORK
E1.3	ROOF ELECTRICAL NEW WORK
E3.0	ELECTRICAL SINGLE LINE DIAGRAM
E4.0	ELECTRICAL SINGLE LINE DIAGRAM
E4.1	VRV WIRING SCHEMATICS

CODE REVIEW DATA

ROJECT INFORMATION

APPLICABLE CODES:

OHIO BUILDING CODE, 2017 OHIO FIRE CODE, 2017 OHIO MECHANICAL CODE, 2017 OHIO PLUMBING CODE, 2017 FUEL GAS:

IFGC. 2015 ELECTRICAL: NATIONAL ELECTRICAL CODE, 2017

ACCESSIBILITY: ICC/ANSI A117.1-2003

<u>CHAPTER 3 — USE AND OCCUPANCY</u>

CLASSIFICATION:

USE = A-3 COURTROOMSECTION 303.4

JPR 01/22/21 ISSUED FOR BID REV BY DATE DESCRIPTION




HEATING-AIR CONDITIONING-FIREPLACES-PLUMBING 805 E. MAIN STREET - ASHLAND, OH P: 419.281.0144 F: 419.281.6971 WWW.ASHLANDCOMFORT CONTROL.COM JOSEPH P. REEP - OHIO PE: #77349 INFO@ASHLANDCOMFORT.COM



Ashland, OH 44805 Ashland County Courthouse HVAC System Upgrades


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JPR	10/12/20		12/31/20
APPROVED BY: JPR	DATE:	CLIENT NO.	JOB NO.
	01/21/21	ASHOOO	220210

DRAWING NAME:

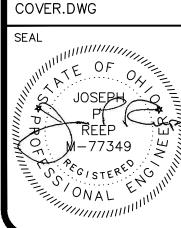

COVER SHEET

LAST EDIT DATE: DRAWING NO. 1/21/21

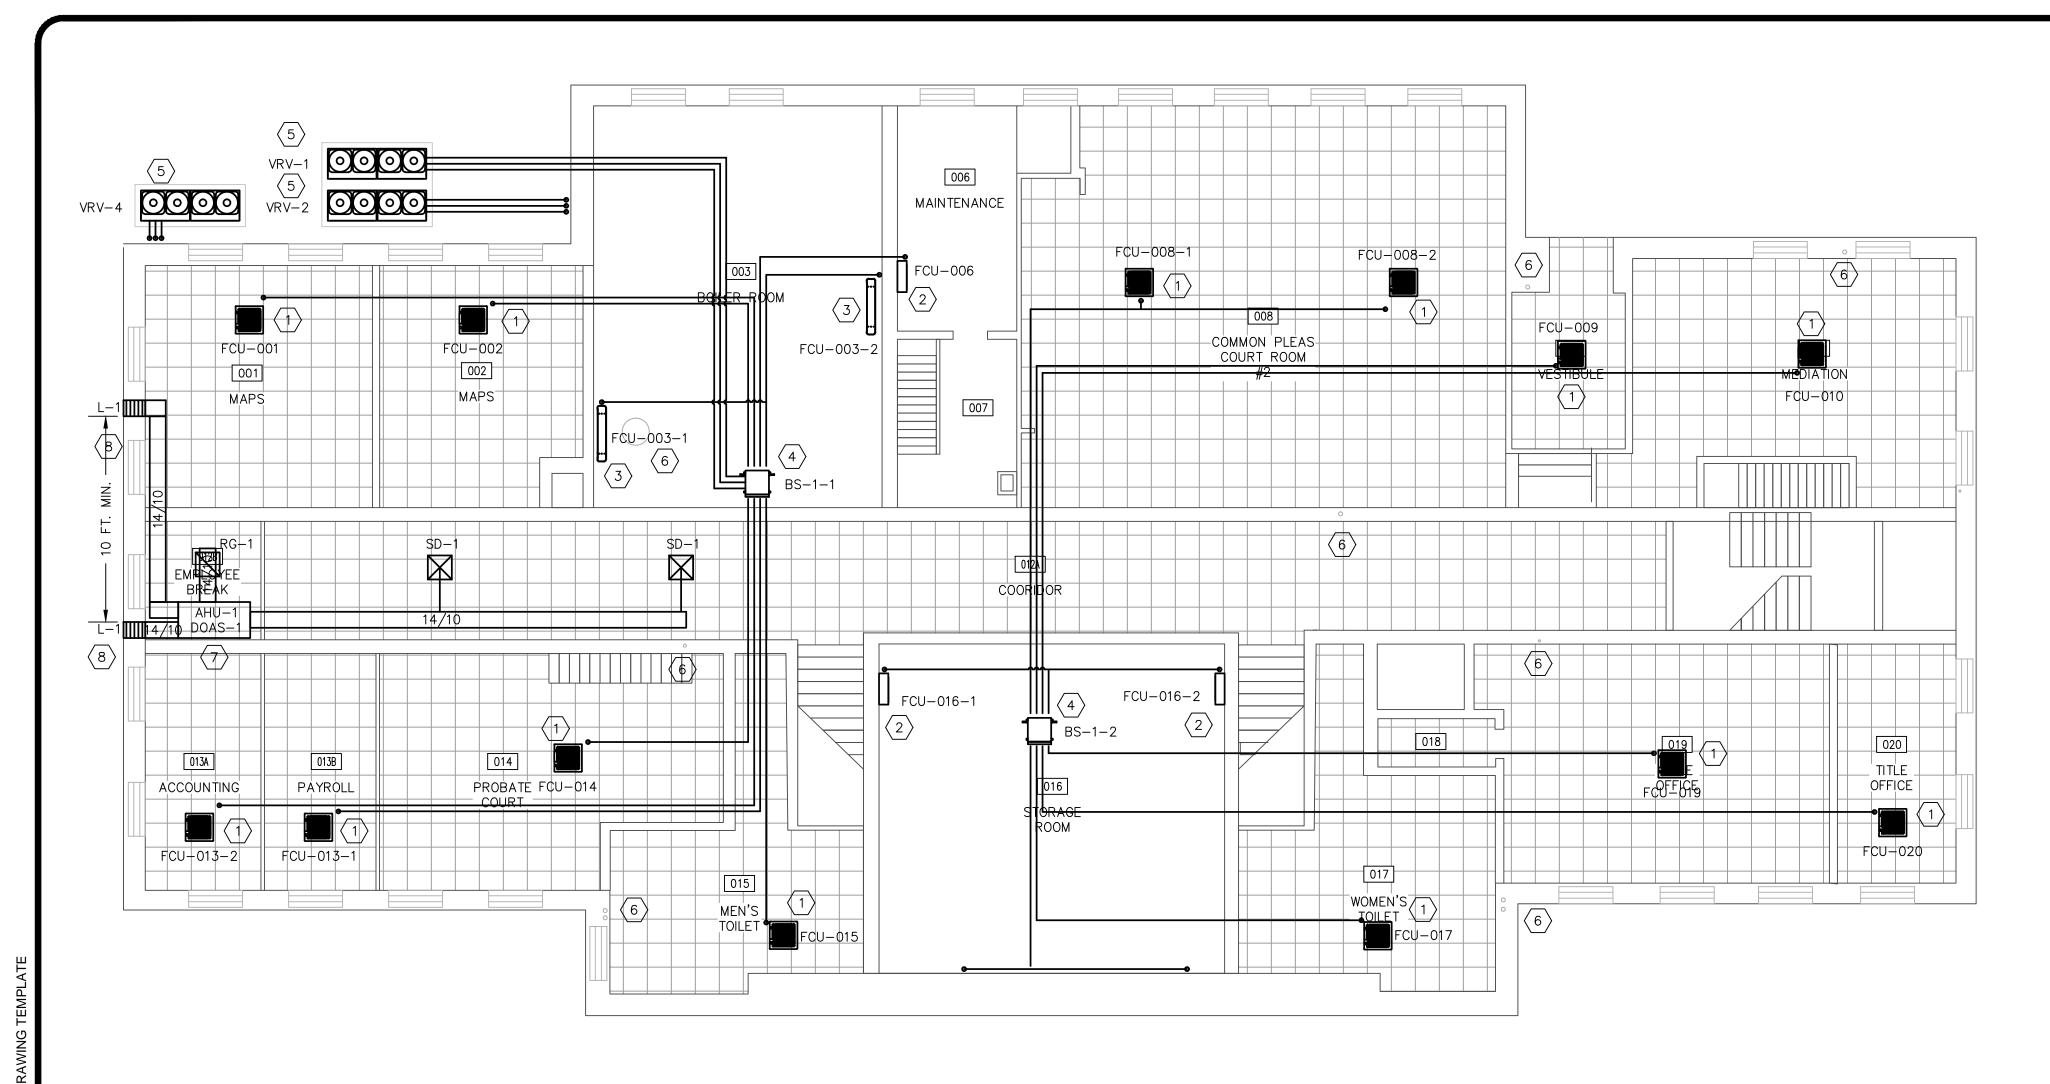

PLAN VIEW GROUND LEVEL HVAC WORK

1/8" = 1'-0"

GR(DUND	LEVEL O	JTD0(DR AIR	VENTILA	ATIONS	SCHEDL	JLE
						AHRAE	62.1 REQUIRE	ED OA
ROOM NO.	SYSTEM	NAME	AREA	OCCUPANCY	USE	CFM/PERSON	CFM/FT²	TOTAL
001	BASEMENT	MAPS	382	1	OFFICES	5	0.06	27.9
002	BASEMENT	MAPS	327	1	OFFICES	5	0.06	24.6
003	BASEMENT	BOILER RM	805	_	STORAGE	_	0.06	48.3
006	BASEMENT	MAINTENANCE	212	1	OFFICES	5	0.06	13.7
007	BASEMENT	MAINTENANCE	140	_	STORAGE	_	0.06	8.4
008	BASEMENT	COMM. PLEA #2	1,322	20	COURT ROOM	5	0.06	179.3
009	BASEMENT	VESTIBULE	180	_	COORDIOR	_	0.06	10.8
010	BASEMENT	MEDIATION	573	8	CONFERENCE	5	0.06	74.5
012	BASEMENT	CORRIDOR	1,606	_	COORIDOR	_	0.06	96.4
013A	BASEMENT	ACCOUNTING	190	2	OFFICES	5	0.06	21.4
013B	BASEMENT	PAYROLL	183	2	OFFICES	5	0.06	21.0
014	BASEMENT	PROBATE CT	507	8	COURT ROOM	5	0.06	70.4
015	BASEMENT	MEN'S TLT	341	_	RESTROOM	_	_	_
016	BASEMENT	STORAGE	788	_	STORAGE	_	0.06	47.3
017	BASEMENT	WOMEN'S TLT	385	_	RESTROOM	_	_	_
018	BASEMENT	STORAGE	39	_	STORAGE	_	0.06	2.3
019	BASEMENT	TITLE OFFICE	554	5	OFFICE	5	0.06	53.2
020	BASEMENT	TITLE OFFICE	197	2	OFFICE	5	0.06	21.8
NOTES:							TOTAL:	721.3

* 70 CFM EXHAUST PER TOILET/URINAL

** OCCUPANCY CALCULATED FROM DEFAULT RATE / 1,000 FT² PER TABLE 403.3.1.1 OF 2017 OMC IF NOT POSTED.

(x) CODED NOTES:

- MECHANICAL CONTRACTOR (M.C.) TO INSTALL ONE (1) NEW 4-WAY CEILING CASSETTE STYLE VRV HEAD IN EXISTING CEILING GRID. SUSPEND/SUPPORT CASSETTE FROM STRUCTURE ABOVE IN ACCORDANCE WITH MANUFACTURER RECOMMENDATIONS USING SYSTEM OF 3/8" THREADED ROD, WASHERS & NUTS AND/OR GRIPPLE AIRCRAFT CABLE. GRAVITY DRAIN CONDENSATE TO NEAREST PLUMBING STACK, FLOOR DRAIN OR UTILITY SINK (IF POSSIBLE), OTHERWISE UTILIZE BUILT-IN CONDENSATE LIFT MECHANISM TO PUMP TO NEAREST APPROPRIATE DISPOSAL POINT. REFER TO EQUIPMENT SCHEDULES AND MANUFACTURER PROVIDED PIPING DIAGRAMS AND MANUALS FOR SPECIFIC INSTALLATION REQUIREMENTS.
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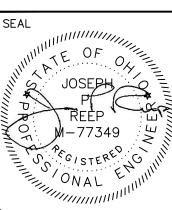


Ashland County Courthouse

HVAC	Syste	m Upgrades			
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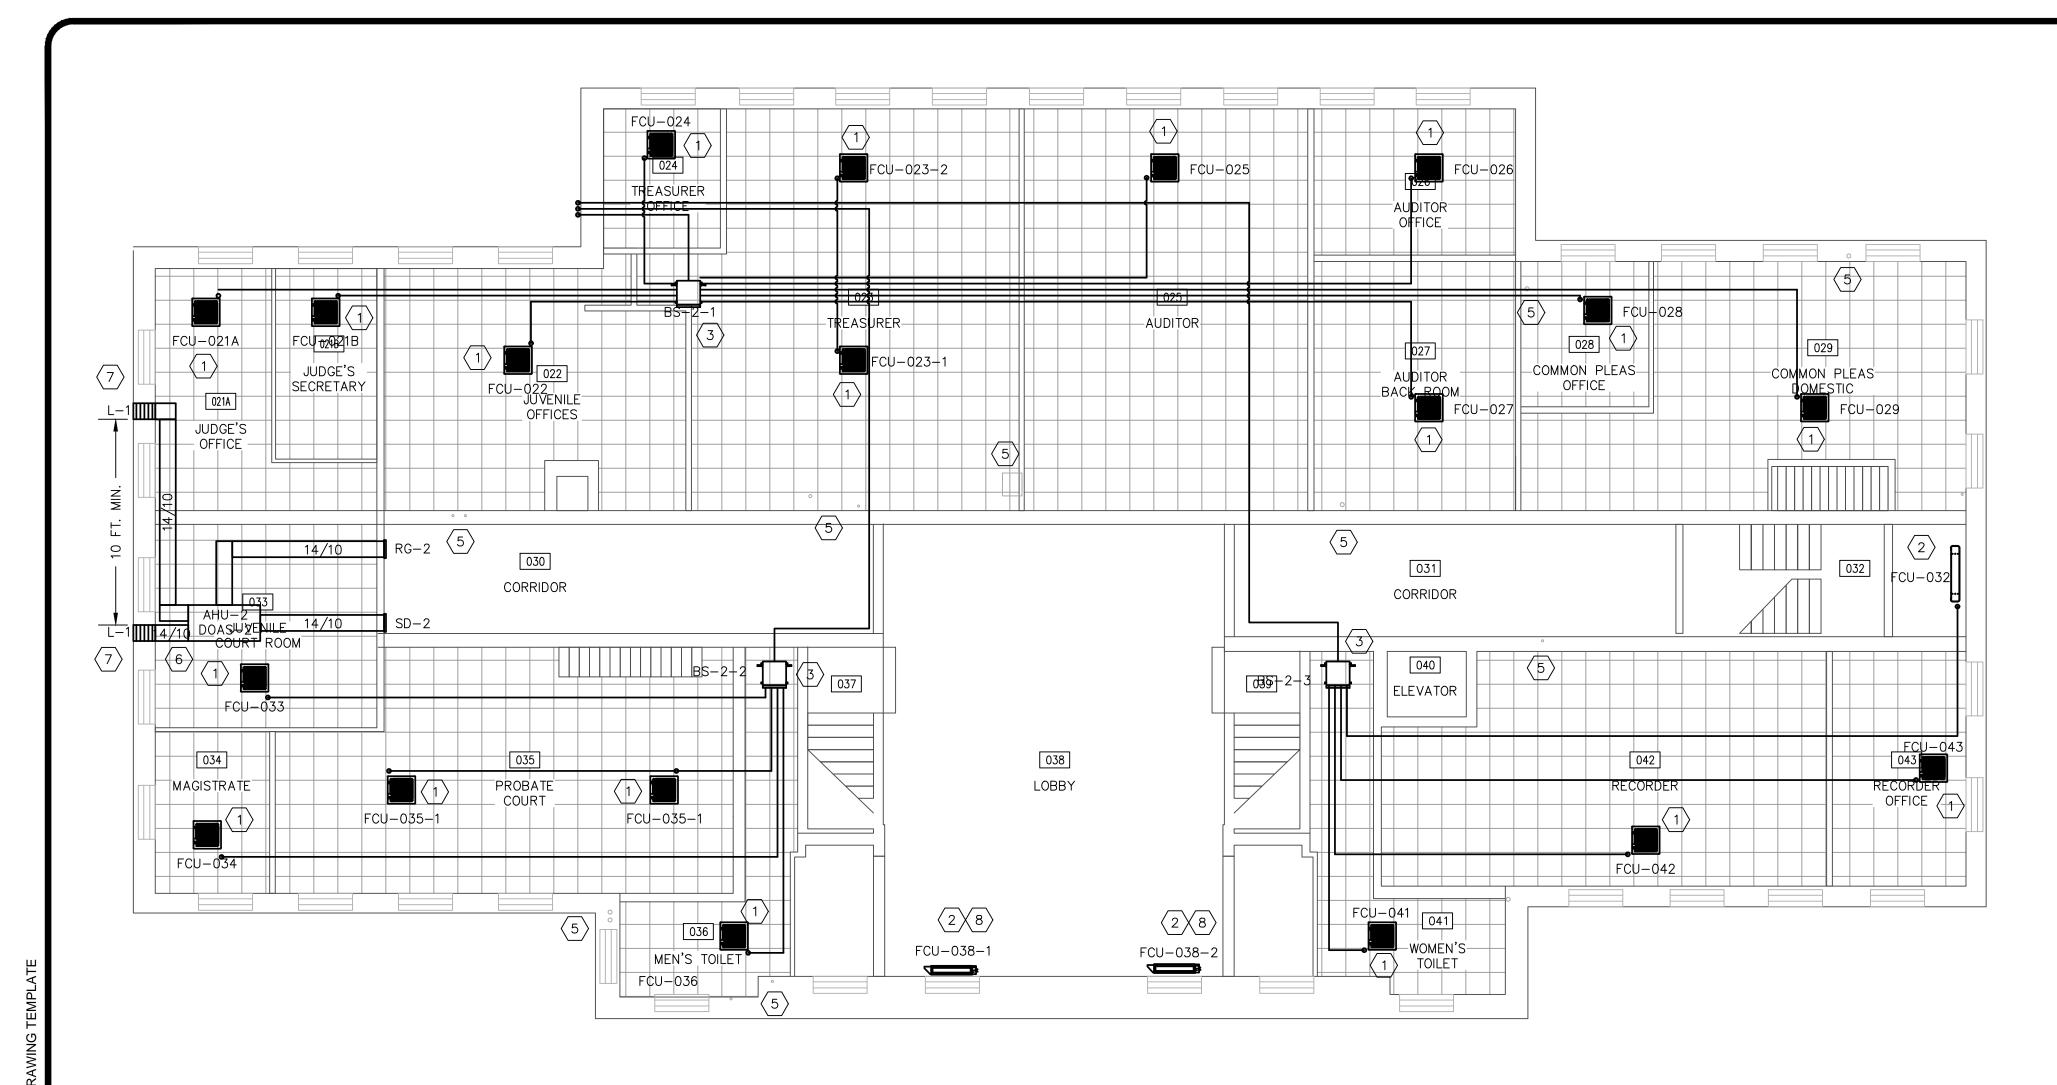
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APPROVED BY: JPR	DATE:	CLIENT NO.	JOB NO.
	01/21/21	ASHOOO	220210

DRAWING NAME: 220210 - HVAC.DWG



LOWER LEVEL HVAC NEW WORK PLAN

LAST EDIT DATE: 1/21/21 DRAWING NO. M1.0





1/8" = 1'-0"

FIRST FLOOR OUTDOOR AIR VENTILATION SCHEDULE								
						AHRAE	62.1 REQUIRE	ED OA
ROOM NO.	SYSTEM	NAME	AREA	OCCUPANCY	USE	CFM/PERSON	CFM/FT²	TOTAL
021A	1ST FLOOR	JUDGE'S OFFICE	231	1	OFFICE	5	0.06	18.9
021B	1ST FLOOR	JUDGE'S SEC.	134	1	OFFICE	5	0.06	13.0
022	1ST FLOOR	JUVENILE OFF.	494	3	OFFICE	5	0.06	44.6
023	1ST FLOOR	TREAS. OFFICE	113	1	OFFICE	5	0.06	7.8
024	1ST FLOOR	TREASURER	898	4	OFFICE	5	0.06	73.9
025	1ST FLOOR	AUDITOR	791	4	OFFICE	5	0.06	67.5
026	1ST FLOOR	AUDITOR OFF.	205	2	OFFICE	5	0.06	22.3
027	1ST FLOOR	AUDIT BACK RM	349	8	OFFICE	5	0.06	60.9
028	1ST FLOOR	COMM PLEA OFF.	129	2	OFFICE	5	0.06	17.7
029	1ST FLOOR	COMM PLEA DOM.	630	4	COURT RM	5	0.06	57.8
030	1ST FLOOR	CORRIDOR	371	_	COORIDOR	_	0.06	22.3
031	1ST FLOOR	CORRIDOR	340	_	COORIDOR	_	0.06	20.4
032	1ST FLOOR	STAIRCASE	221	_	COORIDOR	_	0.06	13.3
033	1ST FLOOR	JUV COURT RM	313	8	COURT RM	5	0.06	58.8
034	1ST FLOOR	MAGISTRATE	128	1	OFFICE	5	0.06	12.7
035	1ST FLOOR	PROBATE COURT	719	10	COURT RM	5	0.06	93.1
036	1ST FLOOR	MEN'S TOILET	199	_	RESTROOM	_	_	_
037	1ST FLOOR	STAIRCASE	187	_	COORIDOR	_	0.06	11.2
038	1ST FLOOR	LOBBY	1,064	10	MAIN ENTRY	5	0.06	113.8
039	1ST FLOOR	STAIRCASE	184	_	COORIDOR	_	0.06	11.0
040	1ST FLOOR	ELEVATOR	36	_	ELEVATOR	_	_	_
041	1ST FLOOR	WOMEN'S TLT	223	_	RESTROOM	_	_	_
042	1ST FLOOR	RECORDER	675	2	OFFICE	5	0.06	50.5
043	1ST FLOOR	RECORDER OFF.	218	2	OFFICE	5	0.06	23.1
NOTES:							TOTAL:	814.4
* 70 CFM EX	(HAUST PER	TOILET/URINAL						

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- EXISTING PLUMBING STACK OR POTENTIAL CONDENSATE DISPOSAL LOCATION.
- 6. MC TO SUSPEND NEW AIR HANDLER, COIL AND VRV CONTROLLER ABOVE EXISTING ACOUSTICAL CEILING. INCLUDE PLYWOOD AND SECONDARY DRAIN PAN WITH CONDENSATE COP OR EQUIVALENT. ALL DUCTWORK TO BE INSULATED WITH R-8 INSULATION, LIMITING FLEX RUNS TO LENGTHS LESS THAN 5 FEET.
- 7. NEW INTAKE AND EXHAUST LOUVERS TO BE INSTALLED, FASTENED AND SEALED WEATHER TIGHT ON THE BUILDING EXTERIOR.
- 8. REMOVE EXISTING RADIATOR AND CAP STEAM LINES BENEATH FLOOR IN LOBBY ENCLOSURES TO PROVIDE ADEQUATE SPACE NECESSARY FOR VRV CONSOLE.

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DESIGNERS:



SHLAND COMFORT CONTROL

805 E. MAIN STREET - ASHLAND, OH
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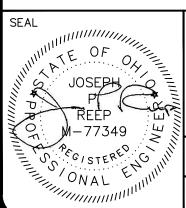
PROJECT



Ashland County Courthouse HVAC System Upgrades

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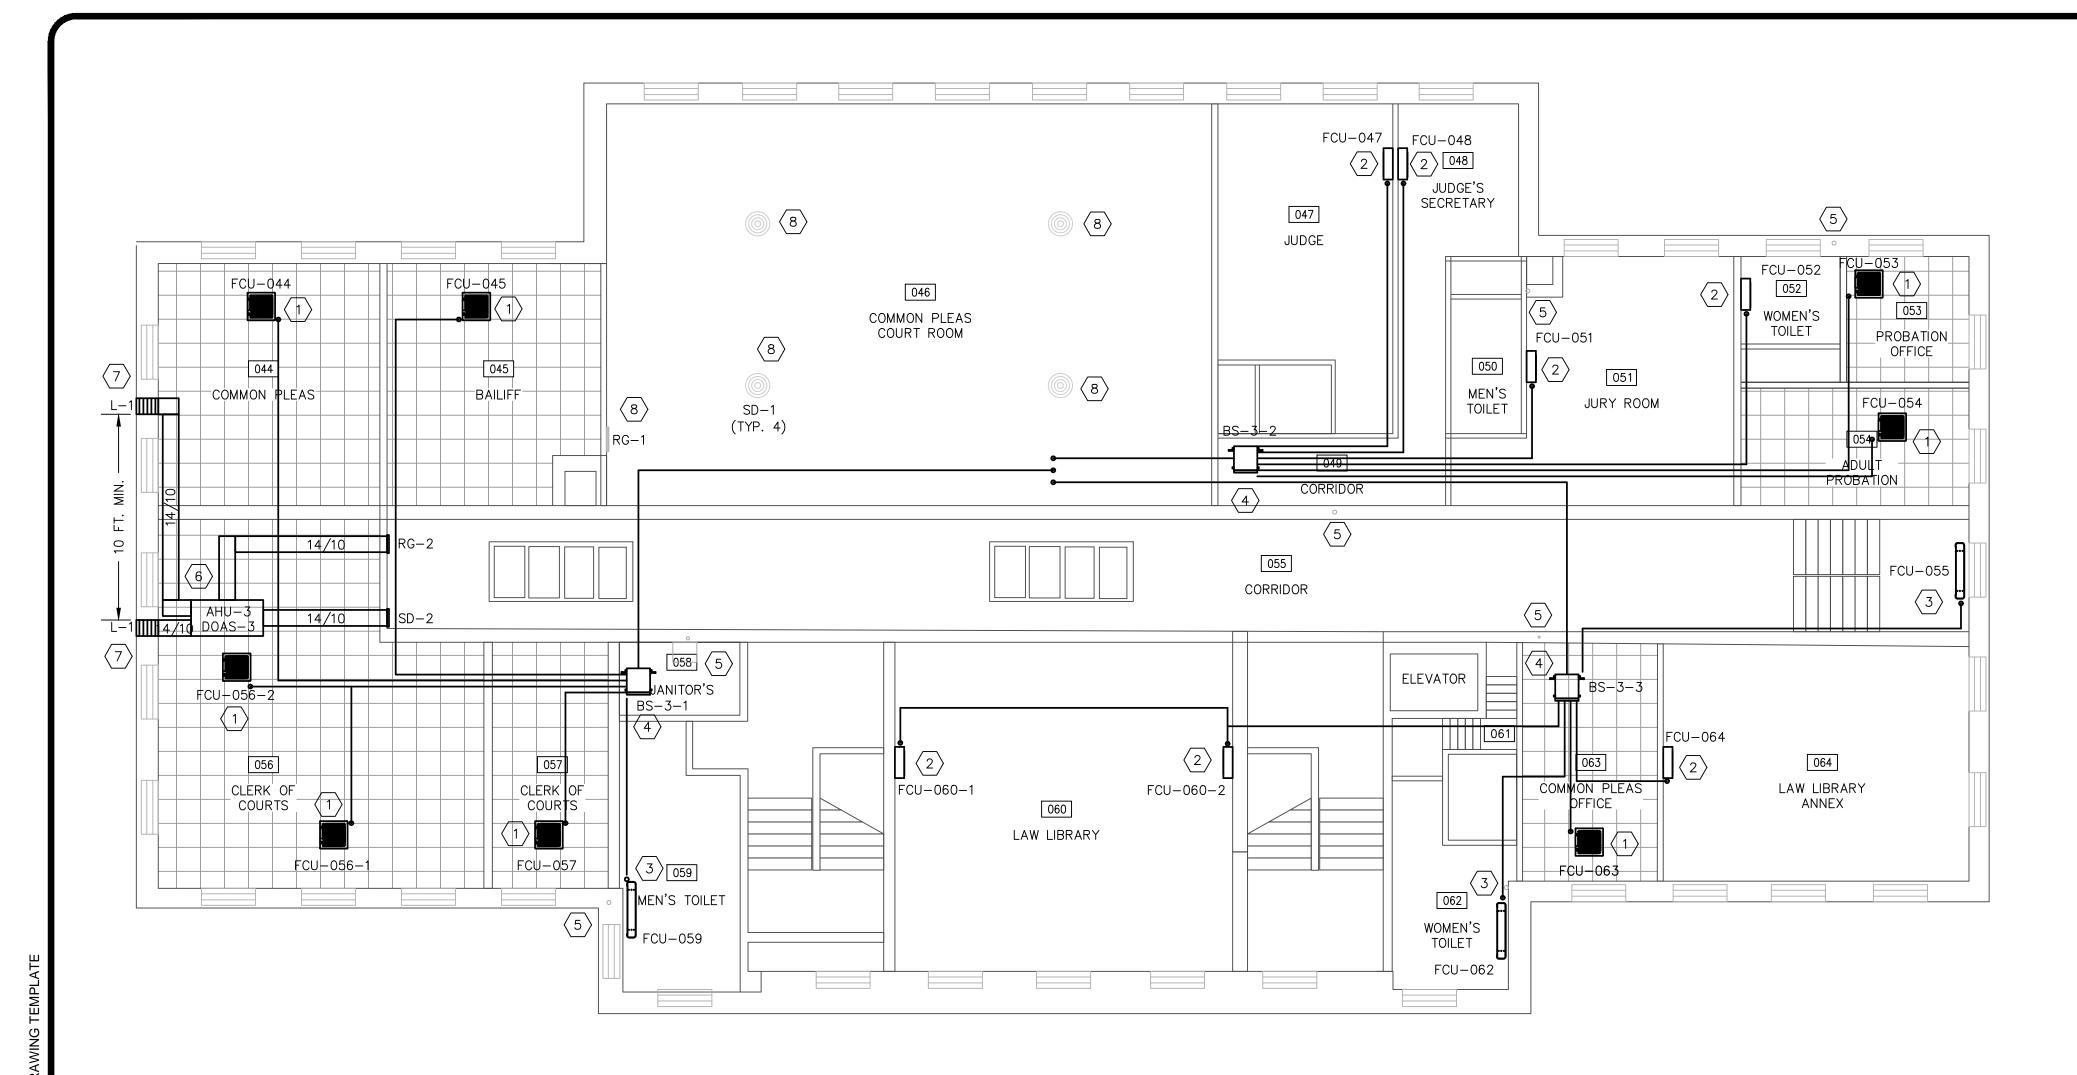
DRAWING NAME: 220210 — HVAC.DW



1ST FLOOR HVAC NEW WORK PLAN

LAST EDIT DATE: 1/21/21 DRAWING NO. SCALE: DRAWING NO. M1.1

** OCCUPANCY CALCULATED FROM DEFAULT RATE / 1,000 FT2 PER TABLE 403.3.1.1 OF 2017 OMC IF NOT POSTED.



A PLAN VIEW
2ND FLOOR HVAC WORK

1/8" = 1'-0"

SE(CONDF	FLOOR O	UTDO(OR AIR	VENTIL	ATION	SCHEDL	JLE
						AHRAE	62.1 REQUIRE	ED OA
ROOM NO.	SYSTEM	NAME	AREA	OCCUPANCY	USE	CFM/PERSON	CFM/FT²	TOTAL
044	2ND FLOOR	COMMON PLEAS	372	1	OFFICE	5	0.06	27.3
045	2ND FLOOR	BAILIFF	351	1	OFFICE	5	0.06	26.1
046	RTU	CO. PL CRT RM	1,689	118	COURT ROOM	5	0.06	691.3***
047	2ND FLOOR	JUDGE'S OFF	400	1	OFFICE	5	0.06	29.0
048	2ND FLOOR	JUDGE'S SEC	128	1	OFFICE	5	0.06	12.7
049	2ND FLOOR	COORIDOR	167	_	COORIDOR	_	0.06	10.0
050	2ND FLOOR	MEN'S TLT	66	_	RESTROOM	_	_	<u> </u>
051	2ND FLOOR	JURY ROOM	394	15	CONFERENCE	5	0.06	98.6
052	2ND FLOOR	WOMEN'S TLT	86	_	RESTROOM	_	_	_
053	2ND FLOOR	PROBATION OFF	107	2	OFFICE	5	0.06	16.4
054	2ND FLOOR	ADLT PROBATION	186	2	OFFICE	5	0.06	21.2
055	2ND FLOOR	COORIDOR	1,217	_	COORIDOR	_	0.06	73.0
056	2ND FLOOR	CLRK OF CRTS	745	2	OFFICE	5	0.06	54.7
057	2ND FLOOR	CLRK OF CRTS	198	1	OFFICE	5	0.06	16.9
058	2ND FLOOR	JANITOR'S	61	_	STORAGE	_	0.06	3.7
059	2ND FLOOR	MEN'S TLT	204	_	RESTROOM	_	_	_
060	2ND FLOOR	LAW LIBRARY	772	6	LIBRARY	5	0.12	122.6
061	2ND FLOOR	STAIRCASE	52	_	COORIDOR	_	0.06	3.1
062	2ND FLOOR	WOMEN'S TLT	140	_	RESTROOM	_	_	_
063	2ND FLOOR	COMM PL OFF	224	2	OFFICE	5	0.06	23.4
064	2ND FLOOR	LAW LIB. ANX.	498	6	LIBRARY	5	0.12	89.8
NOTES:							TOTAL:	628.5

* 70 CFM EXHAUST PER TOILET/URINAL

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*** LARGE COMMON PLEAS COURT ROOM IS ON A DEDICATED ROOFTOP UNIT WITH ITS OWN MEANS OF OUTSIDE AIR

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 INSTALLATION REQUIREMENTS.
- 3. M.C. TO INSTALL ONE (1) CONSOLE STYLE VRV UNIT. SUPPORT UNIT FROM EXISTING FLOOR IN ACCORDANCE WITH MANUFACTURER RECOMMENDATIONS. GRAVITY DRAIN CONDENSATE TO NEAREST PLUMBING STACK, FLOOR DRAIN OR UTILITY SINK (IF POSSIBLE), OTHERWISE PROVIDE OPTIONAL PUMP TO DISCHARGE CONDENSATE TO NEAREST APPROPRIATE DISPOSAL POINT. REFER TO EQUIPMENT SCHEDULES AND MANUFACTURER PROVIDED PIPING DIAGRAMS AND MANUALS FOR SPECIFIC INSTALLATION REQUIREMENTS.
- 4. M.C. TO INSTALL BRANCH SELECTOR UNIT IN APPROXIMATE LOCATION SHOWN. REFER TO EQUIPMENT SCHEDULES AND MANUFACTURER PROVIDED PIPING DIAGRAMS AND MANUALS FOR SPECIFIC INSTALLATION REQUIREMENTS. SELECTOR BOX AND REFRIGERANT LINES TO BE CONCEALED IN BUILDING ATTIC WHERE POSSIBLE. EXPOSED PIPING SHALL BE RUN NEAT, LEVEL AND CONCEALED IN PAINTABLE LINE—HIDE.
- EXISTING PLUMBING STACK OR POTENTIAL CONDENSATE DISPOSAL LOCATION.
- 6. MC TO SUSPEND NEW AIR HANDLER, COIL AND VRV CONTROLLER ABOVE EXISTING ACOUSTICAL CEILING. INCLUDE PLYWOOD AND SECONDARY DRAIN PAN WITH CONDENSATE COP OR EQUIVALENT. ALL DUCTWORK TO BE INSULATED WITH R-8 INSULATION, LIMITING FLEX RUNS TO LENGTHS LESS THAN 5 FEET.
- 7. NEW INTAKE AND EXHAUST LOUVERS TO BE INSTALLED, FASTENED AND SEALED WEATHER TIGHT ON THE BUILDING EXTERIOR.
- 8. EXISTING DUCTWORK AND DIFFUSERS IN COURTROOM TO REMAIN.

0	JPR	01/22/21	ISSUED FOR BID
REV	BY	DATE	DESCRIPTION

DESIGNERS:



SHLAND COMFORT CONTROL

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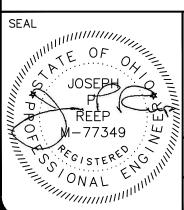
PROJECT



Ashland County Courthouse HVAC System Upgrades

DRAWN BY:	ORIGIN DATE:	DESIGNED BY:	DATE:		
JPR	10/12/20	JPR	12/31/20		
APPROVED BY:	DATE: 01 /21 /21	CLIENT NO.	JOB NO.		

DRAWING NAME: 220210 — HVAC.DW



^E 2ND FLOOR HVAC NEW WORK PLAN

LAST EDIT DATE:
1/21/21


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DRAWING NO.

1/21/21

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PLOT DATE \ TIME: 1/21/2021 11:14:29 PM



©CODED NOTES:

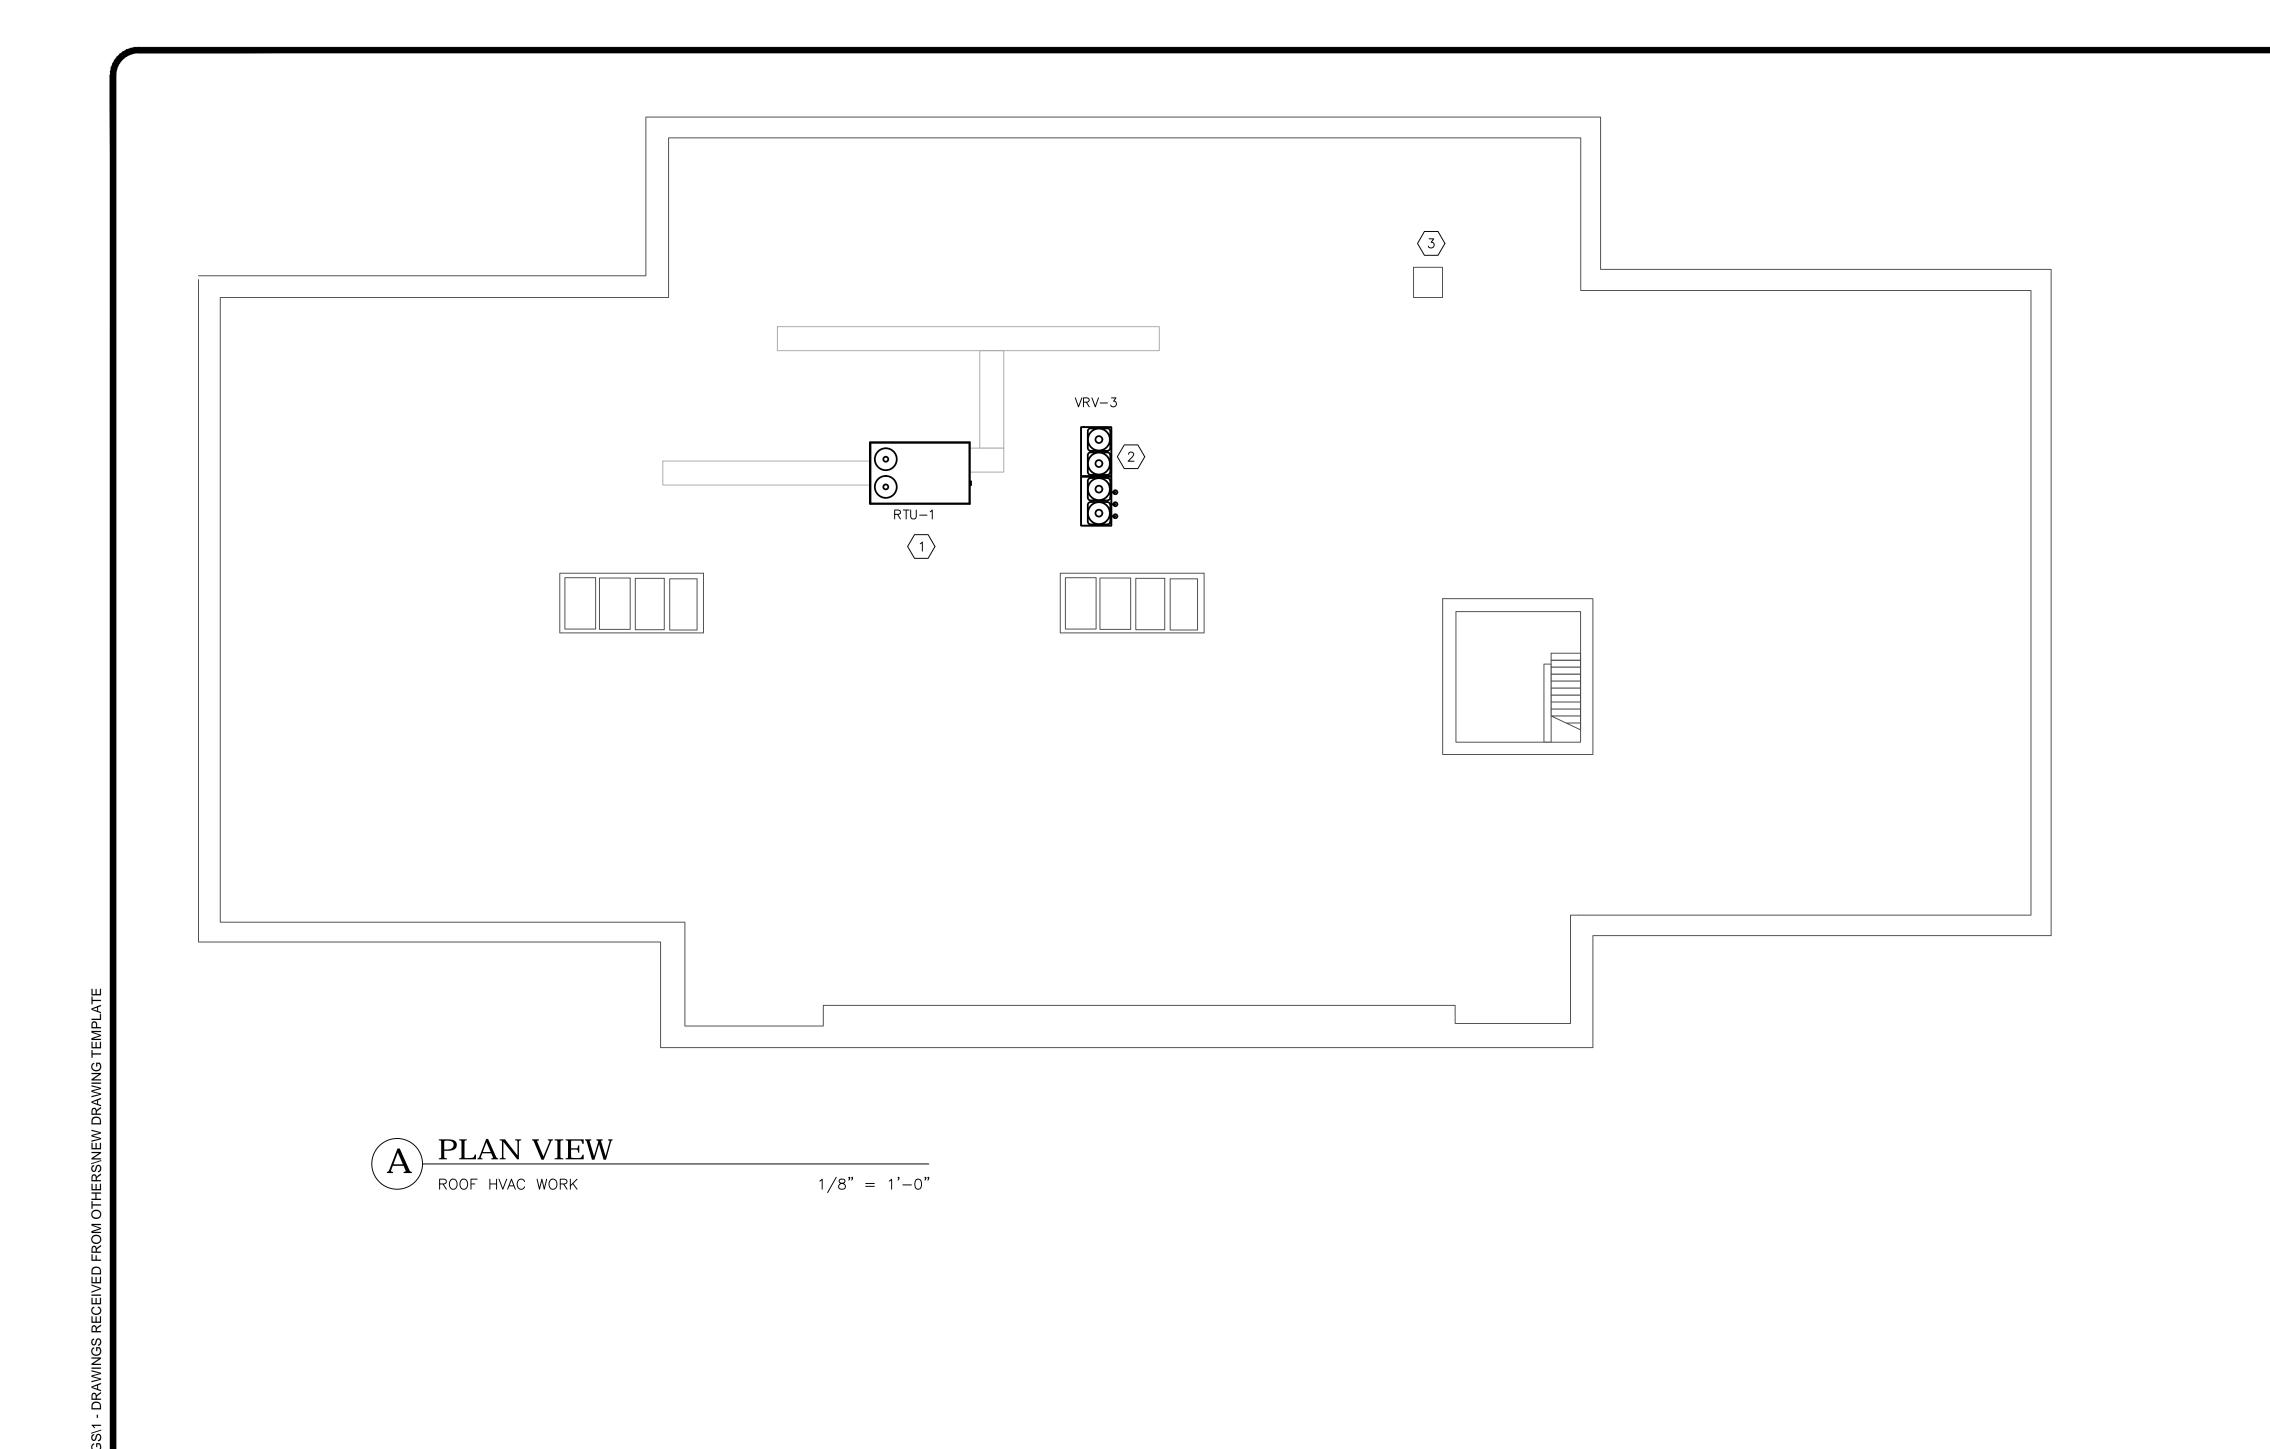- MECHANICAL CONTRACTOR (M.C.) TO REPLACE ONE (1) EXISTING GAS/ELECTRIC, HORIZONTAL DISCHARGE, PACKAGED ROOFTOP UNIT DEDÍCATED TO MUNICIPAL COURTROOM. UNIT TO INCLUDE ALL ACCESSORIES AND OPTIONS AS SCHEDULED AND INDICATED IN THIS DRAWING PACKAGE. RE-USE EXISTING DUCTWORK AND AIR DEVICES AS POSSIBLE AND SEAL NEW AND EXISTING COMPONENTS FOR PROTECTION AGAINST WATER INFILTRATION.
- . M.C. TO SET NEW VRV OUTDOOR UNIT ON ROOF ON EXISTING STRUCTURAL STEEL SUPPORT ADJACENT TO PACKAGED ROOFTOP UNIT. MC TO BE RESPONSIBLE FOR PATCHING ALL NEW ROOF PENETRATIONS AND COORDINATING WITH COUNTY PREFERRED ROOFING CONTRACTOR SO AS NOT TO VOID ANY EXISTING ROOF
- 5. EXISTING ATTIC ACCESS HATCH.

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REV	BY	DATE	DESCRIPTION




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142 West 2nd Street Ashland, OH 44805 Ashland County Courthouse HVAC System Upgrades

DRAWN BY: JPR	ORIGIN DATE: 10/12/20	DESIGNED BY: JPR	DATE: 12/31/20
APPROVED BY: JPR	DATE: 01/21/21	CLIENT NO. ASHOOO	JOB NO.

DRAWING NAME: 220210 - HVAC.DWG




ROOF HVAC NEW WORK PLAN

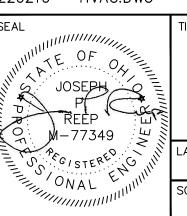LAST EDIT DATE: 1/21/21 SCALE: DRAWING NO. M1.3

		ı				1					VOLUME			UNIT SCHEDUL	E			
TAG	ROOM	NOMINAL TONNAGE	COND. UNIT	ZONE C/O	SUPPLY FAN AIRFLOW RATE		COOLING CAPACITY SENSIBLE BTU/h	i	HEATING CAPA TOTAL BTU/h	EA DB	VOLTAGE/PH	ELECTR MCA	MOP	DIMENSIONS WxHxD (IN.) WEIGHT	MAKE	MODEL TYPE	OPTIONS & ACC.	NOTES
FCU-001	MAPS	0.6	VRV-1	YES	307 CFM	6,823	4,958	75/64°F	8,527	70 ° F	208/230V, 1PH	0.3	15.0	22.6x10.2x22.6 35.3 LBS	DAIKIN	FXZQ07TAVJU 4-WAY CASSETTE (2'x2')	BRC1E73 (1), BYFQ60C3W1W (1)	1-2
FCU-002	MAPS	0.6	VRV-1	YES	307 CFM	6,823	4,958	75/64°F	8,527	70 ° F	208/230V, 1PH	0.3	15.0	22.6x10.2x22.6 35.3 LBS	DAIKIN	FXZQ07TAVJU 4-WAY CASSETTE (2'x2')	BRC1E73 (1), BYFQ60C3W1W (1)	1-2
FCU-003A	BOILER	0.6	VRV-1	YES	245 CFM	6,687	4,659	75/64°F	8,496	70 ° F	208/230V, 1PH	0.3	15.0	39.4×23.6×8.7 57.3 LBS	DAIKIN	FXLQ07MVJU9 FLOOR STANDING UNIT		1-2
FCU-003B	BOILER	0.6	VRV-1	YES	245 CFM	6,687	4,659	75/64°F	8,496	70°F	208/230V, 1PH	0.3	15.0	39.4x23.6x8.7 57.3 LBS	DAIKIN	FXLQ07MVJU9 FLOOR STANDING UNIT	BRC1E73 (1)	1-2
FCU-006	MAINTENANCE	0.6	VRV-1	YES	260 CFM	6,699	5,167	75/64°F	8,500	70°F	208/230V, 1PH	0.3	15.0	31.3x11.4x9.3 26.5 LBS	DAIKIN	FXAQ07PVJU WALL MOUNTED UNIT	BRC1E73 (1), BYFQ60C3W1W (1)	1-2
FCU-008A	COMM. PLEAS #2	1.3	VRV-1	YES	405 CFM	13,646	8,972	75/64°F	17,057	70 ° F	208/230V, 1PH	0.4	15.0	22.6x10.2x22.6 36.4 LBS	DAIKIN	FXZQ15TAVJU 4-WAY CASSETTE (2'x2')	BYFQ60C3W1W (1)	1-2
FCU-008B	COMM. PLEAS #2	1.3	VRV-1	YES	405 CFM	13,646	8,972	75/64°F	17,057	70 ° F	208/230V, 1PH	0.4	15.0	22.6x10.2x22.6 36.4 LBS	DAIKIN	FXZQ15TAVJU 4-WAY CASSETTE (2'x2')	BRC1E73 (1), BYFQ60C3W1W (1)	1-2
FCU-009	VESTIBULE	0.5	VRV-1	YES	300 CFM	5,118	4,022	75/64°F	6,483	70°F	208/230V, 1PH	0.3	15.0	22.6×10.2×22.6 35.3 LBS	DAIKIN	FXZQ05TAVJU 4-WAY CASSETTE (2'x2')	BRC1E73 (1), BYFQ60C3W1W (1)	1-2
FCU-010	MEDIATION	1.0	VRV-1	YES	353 CFM	10,917	6,942	75/64°F	13,642	70°F	208/230V, 1PH	0.4	15.0	22.6x10.2x22.6 36.4 LBS	DAIKIN	FXZQ12TAVJU 4-WAY CASSETTE (2'x2')	<u> </u>	1-2
FCU-012B	EMP. BREAKROOM	0.5	VRV-1	YES	300 CFM	5,118	4,022	75/64°F	6,483	70°F	208/230V, 1PH	0.3	15.0	22.6x10.2x22.6 35.3 LBS		FXZQ05TAVJU 4-WAY CASSETTE (2'x2')	† · · · · · · · · · · · · · · · · · · ·	1-2
FCU-013A	ACCOUNTING	0.5	VRV-1	YES	300 CFM	5,118	4,022	75/64°F	6,483	70°F	208/230V, 1PH	0.3	15.0	22.6x10.2x22.6 35.3 LBS		FXZQ05TAVJU 4-WAY CASSETTE (2'x2')	<u> </u>	1-2
FCU-013B	PAYROLL	0.5	VRV-1	YES	300 CFM	5,118	4,022	75/64°F	6,483	70°F	208/230V, 1PH	0.3	15.0	22.6x10.2x22.6 35.3 LBS		FXZQ05TAVJU 4-WAY CASSETTE (2'x2')	† · · · · · · · · · · · · · · · · · · ·	1-2
FCU-014	PROBATE CRT.	0.8	VRV-1	YES	317 CFM	8,529	5,659	75/64°F	10,574		208/230V, 1PH	0.3	15.0	22.6x10.2x22.6 35.3 LBS		FXZQ09TAVJU 4-WAY CASSETTE (2'x2')	<u> </u>	1-2
FCU-015	MEN'S RR	0.6	VRV-1	YES	307 CFM	6,823	4,958	75/64°F	8,527		208/230V, 1PH	0.3	15.0	22.6x10.2x22.6 35.3 LBS		FXZQ07TAVJU 4-WAY CASSETTE (2'x2')	BRC1E73 (1), BYFQ60C3W1W (1)	1-2
FCU-016A	STORAGE	0.6	VRV-1	YES	260 CFM	6,699	5,167	75/64°F	8,500	70°F	208/230V, 1PH	0.3	15.0	31.3x11.4x9.3 26.5 LBS		FXAQ07PVJU WALL MOUNTED UNIT		1-2
FCU-016B		0.6	VRV-1	YES	260 CFM	6,699	5,167	75/64°F	8,500		208/230V, 1PH	0.3	15.0	31.3×11.4×9.3 26.5 LBS		FXAQO7PVJU WALL MOUNTED UNIT	BRC1E73 (1)	1-2
FCU-017	WOMEN'S RR	0.6	VRV-1	YES	245 CFM	6,687	4,659	75/64°F	8,496	70°F	208/230V, 1PH	0.3	15.0	39.4×23.6×8.7 57.3 LBS		FXLQ07MVJU9 FLOOR STANDING UNIT	BRC1E73 (1) BYEOGO ZWIW (1)	1-2
FCU 030	TITLE OFFICE	1.0	VRV-1	YES	353 CFM	10,917	6,942	75/64°F	13,642	70°F	208/230V, 1PH	0.4	15.0	22.6x10.2x22.6 36.4 LBS		FXZQ12TAVJU 4-WAY CASSETTE (2'x2')	† · · · · · · · · · · · · · · · · · · ·	1-2
FCU-020	TITLE OFFICE	0.5	VRV-2	YES	300 CFM	5,118	4,022	75/64°F	6,483	70°F	208/230V, 1PH	0.3	15.0	22.6x10.2x22.6 35.3 LBS		FXZQ05TAVJU 4-WAY CASSETTE (2'x2')	†	1-2
FCU-021A	JUDGE'S OFFICE	0.5	VRV-2	YES	300 CFM	5,118	4,022	75/64°F	6,483	70°F	208/230V, 1PH	0.3	15.0	22.6×10.2×22.6 35.3 LBS		FXZQ05TAVJU 4-WAY CASSETTE (2'x2')		1-2
FCU-021B FCU-022	JUDGE'S SECRETARY JUVENILLE OFFICE	1.0	VRV-2 VRV-2	YES YES	300 CFM 353 CFM	5,118 10,917	4,022 6,942	75/64°F 75/64°F	6,483 13,642	70°F 70°F	208/230V, 1PH 208/230V, 1PH	0.3	15.0 15.0	22.6×10.2×22.6 35.3 LBS 22.6×10.2×22.6 36.4 LBS		FXZQ05TAVJU 4-WAY CASSETTE (2'x2') FXZQ12TAVJU 4-WAY CASSETTE (2'x2')		1-2 1-2
FCU-022 FCU-023A	TREASURER	1.0	VRV-2 VRV-2	YES	353 CFM	10,917	6,942	75/64°F	13,642	70°F	208/230V, 1PH	0.4	15.0	22.6x10.2x22.6 36.4 LBS		FXZQ12TAVJU 4-WAY CASSETTE (2'x2')		1-2
FCU-023A	TREASURER	1.0	VRV-2	YES	353 CFM	10,917	6,942	75/64°F	13,642	70°F	208/230V, 1PH	0.4	15.0	22.6x10.2x22.6 36.4 LBS		FXZQ12TAVJU 4-WAY CASSETTE (2'x2')		1-2
FCU-024	TREASURER OFFICE	0.6	VRV-2	YES	260 CFM	6,699	5,167	75/64°F	8,500	70°F	208/230V, 1111 208/230V, 1PH	0.3	15.0	31.3x11.4x9.3 26.5 LBS		FXAQ07PVJU WALL MOUNTED UNIT	BRC1E73 (1)	1-2
FCU-025	AUDITOR	1.5	VRV-2	YES	511 CFM	16,035	10,957	75/64°F	20,121	70°F	208/230V, 1PH	0.6	15.0	22.6×10.2×22.6 41.9 LBS	DAIKIN	FXZQ18TAVJU 4-WAY CASSETTE (2'x2')	 	1-2
FCU-026	AUDITOR'S OFFICE	0.5	VRV-2	YES	300 CFM	5,118	4,022	75/64°F	6,483	70°F	208/230V, 1PH	0.3	15.0	22.6×10.2×22.6 35.3 LBS		FXZQ05TAVJU 4-WAY CASSETTE (2'x2')		1-2
FCU-027	AUDITOR'S BCK RM	0.8	VRV-2	YES	317 CFM	8,529	5,659	75/64°F	10,574	70°F	208/230V, 1PH	0.3	15.0	22.6×10.2×22.6 35.3 LBS		FXZQ09TAVJU 4-WAY CASSETTE (2'x2')	† · · · · · · · · · · · · · · · · · · ·	1-2
FCU-028	COMMON PLEAS OFF.	0.5	VRV-2	YES	300 CFM	5,118	4,022	75/64°F	6,483	70°F	208/230V, 1PH	0.3	15.0	22.6×10.2×22.6 35.3 LBS		FXZQ05TAVJU 4-WAY CASSETTE (2'x2')	†	1-2
FCU-029	COMMON PLEAS DOM.		VRV-2	YES	405 CFM	13,646	8,972	75/64°F	17,057	70°F	208/230V, 1PH	0.4	15.0	22.6x10.2x22.6 36.4 LBS		FXZQ15TAVJU 4-WAY CASSETTE (2'x2')	<u> </u>	1-2
FCU-032	TITLE OFFICE	0.6	VRV-2	YES	245 CFM	6,687	4,659	75/64°F	8,496	70 ° F	208/230V, 1PH	0.3	15.0	39.4×23.6×8.7 57.3 LBS			BRC1E73 (1)	1-2
FCU-033	JUVENILE COURT RM	0.6	VRV-2	YES	307 CFM	6,823	4,958	75/64°F	8,527	70 ° F	208/230V, 1PH	0.3	15.0	22.6x10.2x22.6 35.3 LBS		FXZQ07TAVJU 4-WAY CASSETTE (2'x2')	` ,	1-2
FCU-034	MAGISTRATE	0.5	VRV-2	YES	300 CFM	5,118	4,022	75/64°F	6,483	70 ° F	208/230V, 1PH	0.3	15.0	22.6x10.2x22.6 35.3 LBS		FXZQ05TAVJU 4-WAY CASSETTE (2'x2')		1-2
FCU-035A	PROBATE COURT	0.8	VRV-2	YES	317 CFM	8,529	5,659	75/64°F	10,574	70°F	208/230V, 1PH	0.3	15.0	22.6×10.2×22.6 35.3 LBS	DAIKIN	FXZQ09TAVJU 4-WAY CASSETTE (2'x2')	BRC1E73 (1), BYFQ60C3W1W (1)	1-2
FCU-035B	PROBATE COURT	0.8	VRV-2	YES	317 CFM	8,529	5,659	75/64°F	10,574	70 ° F	208/230V, 1PH	0.3	15.0	22.6x10.2x22.6 35.3 LBS	DAIKIN	FXZQ09TAVJU 4-WAY CASSETTE (2'x2')	BRC1E73 (1), BYFQ60C3W1W (1)	1-2
FCU-036	MEN'S RR	0.5	VRV-2	YES	300 CFM	5,118	4,022	75/64°F	6,483	70 ° F	208/230V, 1PH	0.3	15.0	22.6x10.2x22.6 35.3 LBS	DAIKIN	FXZQ05TAVJU 4-WAY CASSETTE (2'x2')	BRC1E73 (1), BYFQ60C3W1W (1)	1-2
FCU-038A	LOBBY	1.0	VRV-1	YES	280 CFM	10,698	6,952	75/64°F	13,499	70 ° F	208/230V, 1PH	0.5	15.0	44.9×23.6×8.7 66.1 LBS	DAIKIN	FXLQ12MVJU9 FLOOR STANDING UNIT	BRC1E73 (1)	1-2
FCU-038B	LOBBY	1.0	VRV-1	YES	280 CFM	10,698	6,952	75/64°F	13,499	70°F	208/230V, 1PH	0.5	15.0	44.9×23.6×8.7 66.1 LBS	DAIKIN	FXLQ12MVJU9 FLOOR STANDING UNIT	BRC1E73 (1)	1-2
FCU-041	WOMEN'S RR	0.5	VRV-3	YES	300 CFM	5,118	4,022	75/64°F	6,483	70 ° F	208/230V, 1PH	0.3	15.0	22.6x10.2x22.6 35.3 LBS	DAIKIN	FXZQ05TAVJU 4-WAY CASSETTE (2'x2')	BRC1E73 (1), BYFQ60C3W1W (1)	1-2
FCU-042	RECORDER	1.3	VRV-3	YES	405 CFM	13,646	8,972	75/64°F	17,057	70 ° F	208/230V, 1PH	0.4	15.0	22.6x10.2x22.6 36.4 LBS	DAIKIN	FXZQ15TAVJU 4-WAY CASSETTE (2'x2')	BRC1E73 (1), BYFQ60C3W1W (1)	1-2
FCU-043	RECORDER'S OFF.	0.5	VRV-3	YES	300 CFM	5,118	4,022	75/64°F	6,483	70 ° F	208/230V, 1PH	0.3	15.0	22.6×10.2×22.6 35.3 LBS	DAIKIN	FXZQ05TAVJU 4-WAY CASSETTE (2'x2')	BRC1E73 (1), BYFQ60C3W1W (1)	1-2
FCU-044	COMMON PLEAS	0.8	VRV-3	YES	317 CFM	8,529	5,659	75/64°F	10,574	70 ° F	208/230V, 1PH	0.3	15.0	22.6x10.2x22.6 35.3 LBS	DAIKIN	FXZQ09TAVJU 4-WAY CASSETTE (2'x2')	BRC1E73 (1), BYFQ60C3W1W (1)	1-2
FCU-045	BAILIFF	0.8	VRV-3	YES	317 CFM	8,529	5,659	75/64°F	10,574	70°F	208/230V, 1PH	0.3	15.0	22.6x10.2x22.6 35.3 LBS	DAIKIN	FXZQ09TAVJU 4-WAY CASSETTE (2'x2')	BRC1E73 (1), BYFQ60C3W1W (1)	1-2
FCU-047	JUDGE'S OFFICE	0.8	VRV-3	YES	280 CFM	8,499	6,168	75/64°F	10,500	70 ° F	208/230V, 1PH	0.3	15.0	31.3x11.4x9.3 26.5 LBS	DAIKIN	FXAQ09PVJU WALL MOUNTED UNIT	BRC1E73 (1)	1-2
FCU-048	JUDGE'S SECRETARY	0.5	VRV-3	YES	300 CFM	5,118	4,022	75/64°F	6,483	70°F	208/230V, 1PH	0.3	15.0	22.6×10.2×22.6 35.3 LBS	DAIKIN	FXZQ05TAVJU 4-WAY CASSETTE (2'x2')	BRC1E73 (1), BYFQ60C3W1W (1)	1-2
FCU-051	JURY ROOM	0.8	VRV-3	YES	280 CFM	8,499	6,168	75/64°F	10,500	70 ° F	208/230V, 1PH	0.3	15.0	31.3x11.4x9.3 26.5 LBS	DAIKIN	FXAQ09PVJU WALL MOUNTED UNIT	BRC1E73 (1)	1-2
FCU-052	WOMEN'S RR	0.6	VRV-3	YES	260 CFM	6,699	5,167	75/64°F	8,500	70°F	208/230V, 1PH	0.3	15.0	31.3x11.4x9.3 26.5 LBS	DAIKIN	FXAQ07PVJU WALL MOUNTED UNIT	BRC1E73 (1)	1-2
FCU-054	PROBATION OFF.	0.5	VRV-3	YES	300 CFM	5,118	4,022	75/64°F	6,483	70°F	208/230V, 1PH	0.3	15.0	22.6x10.2x22.6 35.3 LBS	DAIKIN	FXZQ05TAVJU 4-WAY CASSETTE (2'x2')	BRC1E73 (1), BYFQ60C3W1W (1)	1-2
FCU-055	CORRIDOR STAIR.	1.0	VRV-3	YES	280 CFM	10,698	6,952	75/64°F	13,499	70°F	208/230V, 1PH	0.5	15.0	44.9×23.6×8.7 66.1 LBS			BRC1E73 (1)	1-2
FCU-056A	CLERK OF COURTS	0.8	VRV-3	YES	317 CFM	8,529	5,659	75/64°F	10,574	70 ° F	208/230V, 1PH	0.3	15.0	22.6×10.2×22.6 35.3 LBS		FXZQ09TAVJU 4-WAY CASSETTE (2'x2')		1-2
FCU-056B	CLERK OF COURTS	0.8	VRV-3	YES	317 CFM	8,529	5,659	75/64°F	10,574	70°F	208/230V, 1PH	0.3	15.0	22.6x10.2x22.6 35.3 LBS		FXZQ09TAVJU 4-WAY CASSETTE (2'x2')	†	1-2
FCU-057	CLERK OF COURTS	0.6	VRV-3	YES	260 CFM	6,699	5,167	75/64°F	8,500	70°F	208/230V, 1PH	0.3	15.0	31.3x11.4x9.3 26.5 LBS		FXAQ07PVJU WALL MOUNTED UNIT	BRC1E73 (1)	1-2
FCU-059	MEN'S RR	0.6	VRV-3	YES	245 CFM	6,687	4,659	75/64°F	8,496	70°F	208/230V, 1PH	0.3	15.0	39.4×23.6×8.7 57.3 LBS		FXLQ07MVJU9 FLOOR STANDING UNIT	BRC1E73 (1)	1-2
FCU-060A	LAW LIBRARY	0.8	VRV-3	YES	280 CFM	8,499	6,168	75/64°F	10,500	70°F	208/230V, 1PH	0.3	15.0	31.3x11.4x9.3 26.5 LBS		FXAQ09PVJU WALL MOUNTED UNIT	BRC1E73 (1)	1-2
	LAW LIBRARY	0.8	VRV-3	YES	280 CFM	8,499	6,168	75/64°F	10,500	70°F	208/230V, 1PH	0.3	15.0	31.3x11.4x9.3 26.5 LBS		FXAQ09PVJU WALL MOUNTED UNIT	BRC1E73 (1)	1-2
FCU-062	WOMEN'S RR	0.6	VRV-3	YES	245 CFM	6,687	4,659	75/64°F	8,496	70°F	208/230V, 1PH	0.3	15.0	39.4×23.6×8.7 57.3 LBS		FXLQ07MVJU9 FLOOR STANDING UNIT	BRC1E73 (1)	1-2
FCU-063	RECORDER'S OFFICE	0.5	VRV-3	YES	300 CFM	5,118	4,022	75/64°F	6,483	70°F	208/230V, 1PH	0.3	15.0	22.6x10.2x22.6 35.3 LBS		FXZQ05TAVJU 4-WAY CASSETTE (2'x2')	† · · · · · · · · · · · · · · · · · · ·	1-2
FCU-064	LAW LIB. ANNEX	1.5	VRV-3	YES	500 CFM	16,097	11,020	75/64°F	19,999	70°F	208/230V, 1PH	0.4	15.0	41.3x11.4x9.3 30.9 LBS		FXAQ18PVJU WALL MOUNTED UNIT	BRC1E73 (1)	1-2
DOAS-1	LOWER LEVEL DOAS	2.5	VRV-4	NO	_	33,780	_	_	37,875	_	120V, 1PH	_	15.0	8.5x15.8x3.1 6.4 LBS	DAIKIN	EKEXV80-US AHU INTEGRATION VALVE	` '	1-2
DOAS-2	1ST LEVEL DOAS	3.0	VRV-4	NO	_	41,969	_	_	47,088	_	120V, 1PH	_	15.0	8.5x15.8x3.1 6.4 LBS	DAIKIN	EKEXV100-US AHU INTEGRATION VALVE	<u> </u>	1-2
DOAS-3	2ND LEVEL DOAS	2.5	VRV-4	NO	_	33,780	_	_	37,875	_	120V, 1PH	_	15.0	8.5x15.8x3.1 6.4 LBS	DAIKIN	EKEXV80-US AHU INTEGRATION VALVE	BRC1E73 (1)	1-2

STANDARD LIMITED WARRANTY: 10-YEAR WARRANTY ON COMPRESSOR AND ALL PARTS
 FITTED WITH A WASHABLE LONG-LIFE FILTER

0	JPR	01/22/21	ISSUED FOR BID
REV	BY	DATE	DESCRIPTION

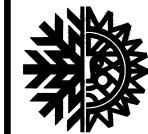

ASHLAND COMFORT CONTROL HEATING-AIR CONDITIONING-FIREPLACES-PLUMBING


805 E. MAIN STREET - ASHLAND, OH P: 419.281.0144 F: 419.281.6971 WWW.ASHLANDCOMFORT CONTROL.COM JOSEPH P. REEP - OHIO PE: #77349 INFO@ASHLANDCOMFORT.COM



142 West 2nd Street Ashland, OH 44805 Ashland County Courthouse HVAC System Upgrades

DRAWN BY:	ORIGIN DATE:	DESIGNED BY:	DATE:
JPR	10/12/20	JPR	12/31/20
approved by:	DATE:	CLIENT NO.	JOB NO.
JPR	01/21/21	ASHOOO	220210

DRAWING NAME: 220210 - HVAC.DWG

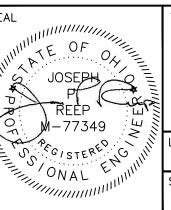

HVAC **EQUIPMENT** SCHEDULES 1

LAST EDIT DATE: 1/21/21 SCALE: DRAWING NO.

M3.0

(VRV)	VARIAE	BLE REFF	RIGERANT	\/\\\\\\\\\\\\\\\\\\\\\\\\\\\\\\\\\\\\	- ZONE	HEAT	RECOVER	Y DEVI	CE SCHEE	DULE
	CONDENSING	MAX CAPACITY		ELECTRICAL	DIMENS	SIONS			ODTIONS A	

	CONDENSING	MAX CAPACITY		ELECTR	RICAL	DIMENSION	NS			OPTIONS &	
TAG	UNIT SERVED	(PER PORT)	VOLTAGE/PH	MCA	MOP	WxHxD (IN.)	WEIGHT	MAKE	MODEL	ACCESORIES	NOTES
BS-1-1	VRV-1	54,000	208/230V, 1PH	1.0	15.0	32.3x11.7x18.9	101.4 LBS	DAIKIN	BS10Q54TVJ	KHFP26A100C (1)	1-4
BS-1-2	VRV-1	54,000	208/230V, 1PH	0.8	15.0	23.3x9.5x23.7	81.6 LBS	DAIKIN	BS8Q54TVJ	_	1-4
BS-2-1	VRV-2	54,000	208/230V, 1PH	1.0	15.0	32.3x11.7x18.9	101.4 LBS	DAIKIN	BS10Q54TVJ	_	1-4
BS-2-2	VRV-2	54,000	208/230V, 1PH	0.4	15.0	13.7x9.5x23.7	48.5 LBS	DAIKIN	BS4Q54TVJ	_	1-4
BS-2-3	VRV-2	54,000	208/230V, 1PH	0.4	15.0	13.7x9.5x23.7	48.5 LBS	DAIKIN	BS4Q54TVJ	_	1-4
BS-3-1	VRV-3	54,000	208/230V, 1PH	0.6	15.0	23.3×9.5×23.7	72.8 LBS	DAIKIN	BS6Q54TVJ	KHFP26A100C (1)	1-4
BS-3-2	VRV-3	54,000	208/230V, 1PH	0.6	15.0	23.3×9.5×23.7	72.8 LBS	DAIKIN	BS6Q54TVJ	KHFP26A100C (1)	1-4
BS-3-3	VRV-3	54,000	208/230V, 1PH	0.6	15.0	23.3x9.5x23.7	72.8 LBS	DAIKIN	BS6Q54TVJ	KHFP26A100C (1)	1-4

- INDIVIDUAL CONTROL AND CHANGEOVER WITH EXTENDED RANGE OF PRODUCT OFFERINGS 4, 6, 8, 10 AND 12 PORT OPTIONS
- . UNLIMITED NUMBER OF UNUSED PORTS PER BOX OR SYSTEM 3. NO DRAIN PIPING NEEDED
- 4. STANDARD LIMITED WARRANTY: 10-YEAR WARRANTY ON ALL PARTS

			Α	ir dev	ICE SC	HEDUL									
SYM	иВОL	SIZE	TYPE	NECK	N.C	MODEL	MANUFACTURER	REMARKS							
SE	D - 1	24/24	LAY-IN	10"ø	_	SCD2424	PRICE	1,2							
SE	D-2	18/10	SURFACE	18/10	_	510	PRICE	1,2							
RO	G-1	24/24	LAY-IN	14"ø	_	PDDR	PRICE	1,2							
RC	G-2	18/10	SURFACE	18/10	_	530	PRICE	1,2							

- BALANCE DAMPER INSTALLED IN BRANCH.
- 1. WHERE RADIAL DAMPER NOT PROVIDED, MANUAL 2. AIR DEVICES SIZED TO MAINTIN N.C. BELOW 20.

	LOUVER SCHEDULE														
NUMBER	NUMBER MAKE MODEL WIDTH INCHES HEIGHT INCHES SQ. FT. MIN. F.A. CFM MAX. APD IN. WC. MAX. APD IN. WC. SERVICE REFERENCE NOTES														
L-1	GREENHECK	ESD-635	20"	20"	1.1	800	0.08"	KYNAR	L-1						

- LOUVERS SUPPLIED WITH BIRD SCREENS.
- 3. DRAINABLE BLADE LOUVER.
- . DIMENSIONS INDICATED ARE NORMAL, EXACT DIMENSIONS SHALL BE COORDINATED WITH THE GENERAL CONTRACTOR.

(VRV) VARIABLE REFRIGERANT VOLUME — AIR—COOLED CONDENSING UNIT SCHE

	(VIV) VARANDEL REPRODERTARIO CONDENSINO ONI SCHEDOLE																					
	NOMINAL	COOLING CAP	ACITY	HEATING CAP	ACITY	REFRIGERANT CH	IARGE	CONNECTION		ELECT	RICAL		DIMENSIO	NS	EFFIC	ENCY (N	ON-DUC	TED)			OPTIONS &	
TAG	TONNAGE	OA DESIGN DB	BTU/h	OA DESIGN DB/V	WB BTU/h	FACTORY CHARGE	ADD'L	RATIO	VOLTAGE/PH	MCA	МОР	RLA	WxHxD (IN.)	WEIGHT	EER IEE	R COP47	COP17	SCHE	MAKE	MODEL	ACCESORIES	NOTES
VRV-1	12-TON	95.0 ℉	145,590	0.0/0.0	154,826	51.6 LBS	N/A	127.8%	208/230V, 3PH	60.8/60.8	70.0/70.0	20.7/20.7	48.9x66.7x30.2	727.5 LBS	12.9 22.	5 3.81	2.2	25.5	DAIKIN	RELQ144TATJA	BHFP26P100U (1)	1-22
VRV-2	12-TON	95.0 ℉	145,143	0.0/0.0	154,727	51.6 LBS	N/A	126.0%	208/230V, 3PH	60.8/60.8	70.0/70.0	20.7/20.7	48.9x66.7x30.2	727.5 LBS	12.9 22.	5 3.81	2.2	25.5	DAIKIN	RELQ144TATJA	BHFP26P100U (1)	1-22
VRV-3	12-TON	95.0 ℉	132,860	0.0/0.0	152,985	51.6 LBS	N/A	106.5%	208/230V, 3PH	60.8/60.8	70.0/70.0	20.7/20.7	48.9x66.7x30.2	727.5 LBS	12.9 22.	5 3.81	2.2	25.5	DAIKIN	RELQ144TATJA	BHFP26P100U (1)	1-22
VRV-4	10-TON	91.0 °F	120,390	0.0/0.0	125,367	25.8 LBS	N/A	88.6%	208/230V, 3PH	83.4/83.4	90.0/90.0	39.3/39.3	48.9x66.7x30.2	793.7 LBS	13.5 23.	3 4.05	2.27	_	DAIKIN	RXLQ120TATJA	_	1-22

- MANUFACTURER MUST BE CERTIFIED, LISTED AND LABELED PER AHRI 1230
- SYSTEM RATING DATA BASED ON DESIGN AMBIENT CONDITIONS FOR COOLING & HEATING SUBMITTED PERFORMANCE DATA MUST BE FULLY DE-RATED FOR ALL COMPONENTS AND ACCESSORIES, INCLUDING BUT NOT LIMITED TO, LINE LENGTH, VERTICAL SEPARATION, CONNECTION RATIO, DESIGN CONDITIONS, CONDENSER COIL COATING
- CONDENSING UNITS MUST HAVE FULLY MODULATING INVERTER COMPRESSORS
- CONDENSING UNITS MUST HAVE AUTO CHANGEOVER FUNCTIONS
- DEMAND LIMITING RELAY CONTACT MUST BE PROVIDED EEV ACTUATORS MUST BE REMOVABLE FROM VALVE BODY WITHOUT DISTURBING THE REFRIGERANT SYSTEM
- FCU THERMOSTATS MUST PROVIDE ±1 DEG. DEAD-BAND SET-POINT AND CONTROL CAPABILITY
- SYSTEM SHALL BE PROVIDED WITH I-TOUCH MANAGER CONTROLLER WITH WEB BASED SOFTWARE FOR DISPLAYING UP TO 8 DIII-NET SYSTEMS WITH 128 INDOOR UNITS PER SYSTEM. PC BY OTHERS
- 10. MANUFACTURERS SUBMITTAL MUST INCLUDE REFRIGERANT PIPING DIAGRAM WITH PIPE DIAMETERS, LENGTHS AND REFRIGERANT VOLUME 11. SUBSTITUTE MANUFACTURER SHALL BE RESPONSIBLE FOR ADDITIONAL PIPING AND REFRIGERANT
- 12. CONTRACTOR TO VERIFY PIPING DIMENSIONS
- 13. INSTALLING CONTRACTOR MUST HAVE SUCCESSFULLY COMPLETED MANUFACTURER'S CERTIFIED INSTALLATION CLASS WITHIN PAST 36 MONTHS
- 14. CONTRACTOR TO FURNISH AND INSTALL INSULATION ON REFRIGERANT PIPING
- 15. MANUFACTURER'S REPRESENTATIVE MUST HAVE LOCAL STOCK OF PARTS AND FACTORY CERTIFIED TECHNICIAN ON STAFF
- 16. MANUFACTURER'S REPRESENTATIVE SHALL PROVIDE PROOF OF ONGOING INSTALLATION TRAINING AT THEIR LOCAL FACILITY FOR AT LEAST THE PAST 5 YEARS 17. MANUFACTURER'S REPRESENTATIVE SHALL PROVIDE PROOF OF CONTINUOUS SALES AND SUPPORT OF THEIR PRODUCTS FOR AT LEAST 15 YEARS
- 18. MECHANICAL CONTRACTOR SHALL BE RESPONSIBLE FOR ALL DIRECT COSTS AND OPERATING COSTS INCREASES FOR 20 YEARS ASSOCIATED WITH ANY DEVIATIONS RESULTING FROM CHANGES IN DESIGN
- 19. MANUFACTURER MUST PROVIDE 10-YEAR PARTS WARRANTY ON ALL FCUS, CONDENSING UNITS AND MODE CHANGEOVER DEVICES. WARRANTY CONDITIONS MUST BE CLARIFIED DURING SUBMITTAL PHASE 20. 3-PHASE AIR COOLED CONDENSING UNITS MUST HAVE PUBLISHED PERFORMANCE DATA WITH 200% CONNECTED CAPACITY
- 21. CONDENSING UNITS MUST BE FURNISHED WITH PROTECTIVE COIL COATING TO WITHSTAND ASTM B117 SALT SPRAY TEST FOR A MINIMUM OF 1000 HOURS. PERFORMANCE OF SYSTEM MUST BE DE-RATED FOR COIL COATING 22. MANUFACTURER MUST CERTIFY AND SUBMIT SYSTEM PERFORMANCE AT EXTREME CONDITIONS OF 122 DEG. FDB AMBIENT IN COOLING MODE AND -22 DEG FWB IN HEATING MODE

(RTU) ROOFTOP UNIT SCHEDULE

	CF	FM		F	AN DATA		COILING COIL				HEATING				
SYMBOL	TOTAL	MIN OA	ESP	H.P.	MOCP	ELECTRICAL	TCC (BTU/h)	SCC (BTU/h)	IEER/EER	FUEL	МВН	AFUE	MAKE	MODEL	NOTES
RTU-1	3,400	691.3	1" w.c.	3.00	60	208/230, 3ø	97,000	71,780	12.7/11	N.G.	210,000	80	DAIKIN	DBG090-150	1–12

- 1. PROVIDE FIELD INSTALLED APPSTAT RTU 2H/2C ECON
- 2. FACTORY INSTALLED GFCI CONVENIENCE OUTLET 3. FACTORY INSTALLED ELECTRO-MECHANICAL CONTROLS
- 4. FACTORY INSTALLED HAIL GUARD
- 5. FACTORY INSTALLED HINGED PANELS 6. FACTORY INSTALLED NON-FUSED DISCONNECT
- 7. FACTORY INSTALLED PHASE MONITOR
- 8. FACTORY INSTALLED R/A SMOKE DETECTOR W/ REMOTE ANNUNCIATOR
- 9. FACTORY INSTALLED 409 SS HEAT EXCHANGER 10. FACTORY INSTALLED 2-STAGE COOLING MODE
- 11. FACTORY INSTALLED ULTRA LOW-LEAK INTERNAL HORIZONTAL ECONOMIZER W/ENTHALPY SENSOR
- 12. RETURN AIR CO2 SENSOR FOR DEMAND CONTROLLED VENTILATION

(DOAS) DEDICATED OUTDOOR AIR SYSTEM SCHEDULE

								\	/																
	NOMINAL	NOMINAL	OUTDOOR	RETURN	EF	FECTIVENE	ESS %		ELECT	RICAL		DIMEN	SIONS	ELEC1	TRIC PRE-I	HEAT		ELE	CTRIC RI	E-HEAT				OPTIONS &	
TAG	TONNAGE	CFM	AIR FLOW	AIR FLOW	SENS.	LAT.	TOTAL-S/W	VOLTAGE/PH	MCA	MROPD	FUSE	WxHxD (IN.)	WEIGHT	VOLTAGE/PH	kW	FLA	FUSE	VOLTAGE/PH	kW	FLA	FUSE	MAKE	MODEL	ACCESORIES	NOTES
DOAS-1	2.5-TON	325-775	721 CFM	600 CFM	70.7	51.65	59.4/66.61	240V, 1PH	5.91	8.41	15A	40x16x60	52.6 LBS	240V, 1PH	2	16.66	35A	240V, 1PH	4	16.6	35A	OXYGEN8	A16	EKEXV80	1-4
DOAS-2	3-TON	500-1,300	814 CFM	680 CFM	74.48	59.02	65.3/71.11	240V, 1PH	9.06	12.96	15A	48×20×72	59.7 LBS	240V, 1PH	2.6	29.16	65A	240V, 1PH	4.8	29.16	65A	OXYGEN8	B20	EKEXV100	1-4
DOAS-3	2.5-TON	325-775	629 CFM	525 CFM	72.26	53.81	61.3/68.3	240V, 1PH	5.91	8.41	15A	40x16x60	50.3 LBS	240V, 1PH	2	16.66	35A	240V, 1PH	4	16.6	35A	OXYGEN8	A16	EKEXV80	1-4

NOTES:

- ELECTRIC PRE-HEAT AND RE-HEAT COILS 3. 2" MERV-13 OA FILTERS, 2" MERV-8 RA FILTERS
- 4. HEATCRAFT DX COILS W/DAIKIN VRV AHU INTEGRATION VALVE KIT.

DUAS	DEDICATED	OUTDOON	AII	3 3 L V	SCHLDULL

DIMENS	SIONS	ELECTRIC PRE-HEAT				ELECTRIC RE-HEAT						OPTIONS &	
(IN.)	WEIGHT	VOLTAGE/PH	kW	FLA	FUSE	VOLTAGE/PH	kW	FLA	FUSE	MAKE	MODEL	ACCESORIES	NOTES
< 60	52.6 LBS	240V, 1PH	2	16.66	35A	240V, 1PH	4	16.6	35A	OXYGEN8	A16	EKEXV80	1-4
×72	59.7 LBS	240V, 1PH	2.6	29.16	65A	240V, 1PH	4.8	29.16	65A	OXYGEN8	B20	EKEXV100	1-4
κ 60	50.3 LBS	240V, 1PH	2	16.66	35A	240V, 1PH	4	16.6	35A	OXYGEN8	A16	EKEXV80	1-4

0 JPR 01/22/21 ISSUED FOR BID DATE DESCRIPTION



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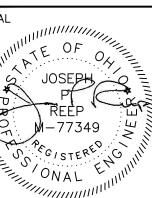


Ashland, OH 44805 Ashland County Courthouse

HVAC	Syste	m̃ Upgra	des
DRAWN BY:	ORIGIN DATE:	DESIGNED BY:	DATE:
IDD	10 /12 /20	IDD	10 /31 /00

DRAWN BY:	ORIGIN DATE:	DESIGNED BY:	DATE:
JPR	10/12/20	JPR	12/31/20
APPROVED BY:	DATE:	CLIENT NO.	JOB NO.
JPR	01/21/21	ASHOOO	220210

DRAWING NAME: 220210 - HVAC.DWG





HVAC **EQUIPMENT** SCHEDULES 2

LAST EDIT DATE: DRAWING NO.

1/21/21 M3.1

CONSTANT AIR VOLUME

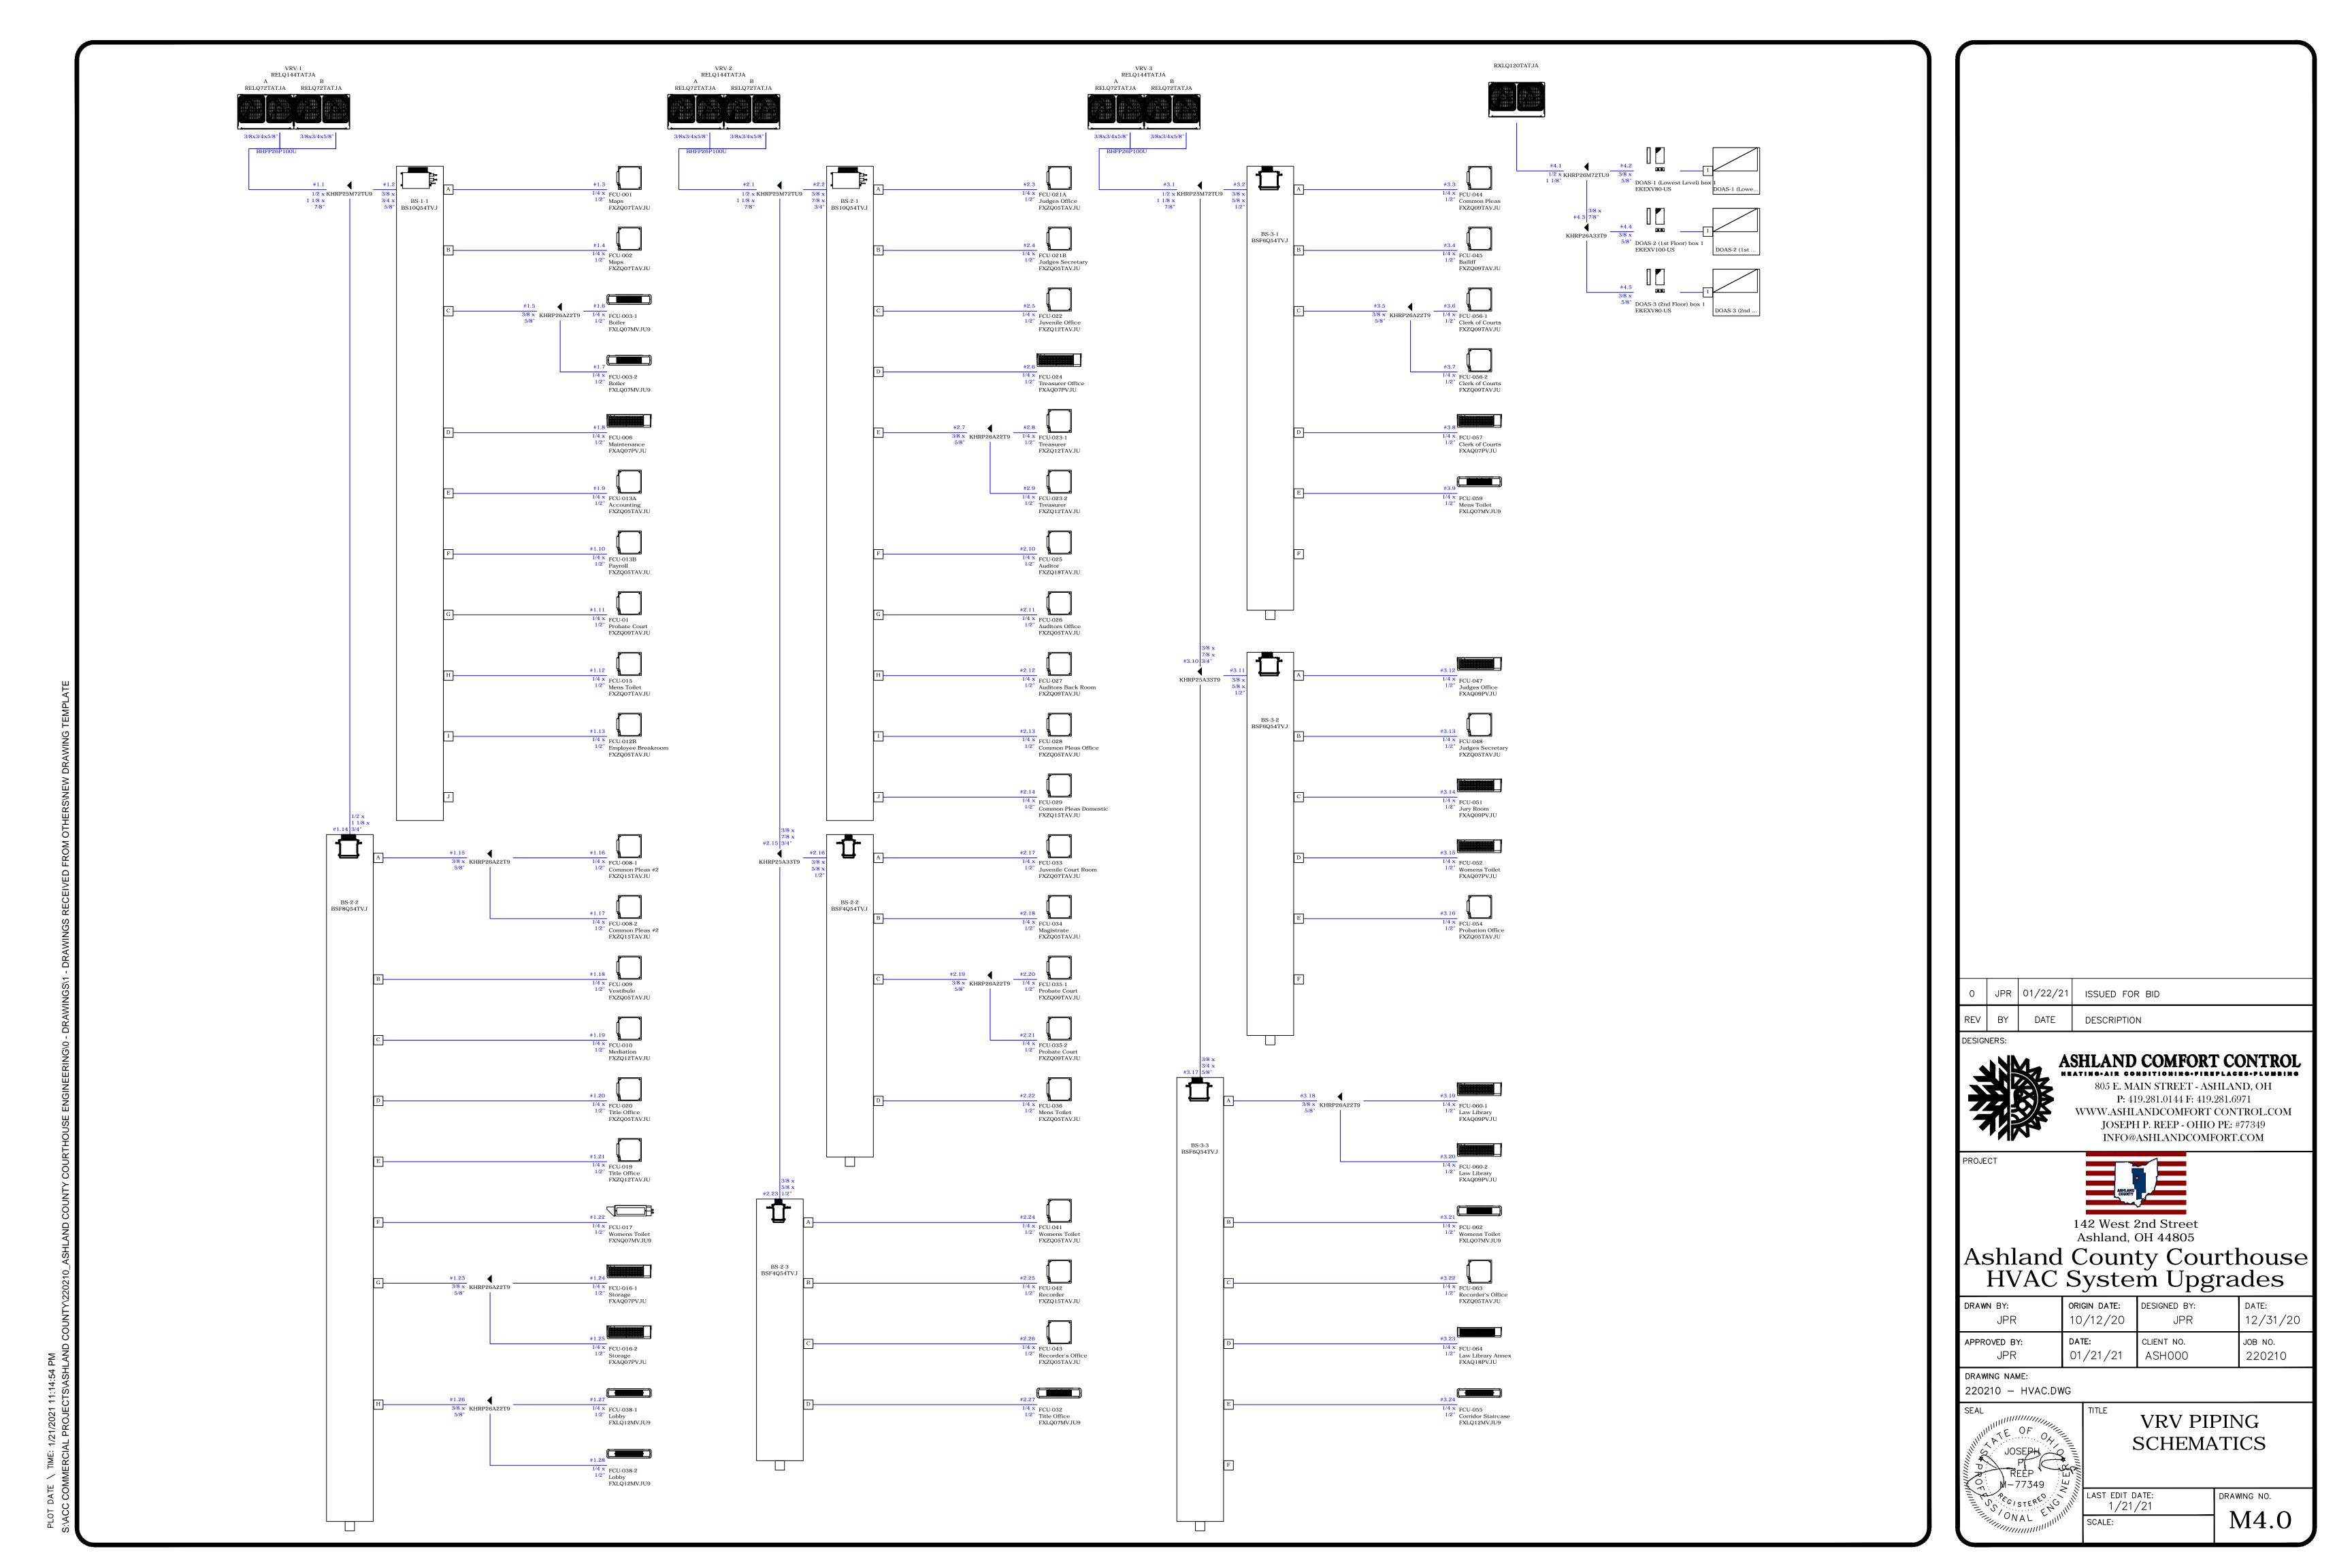

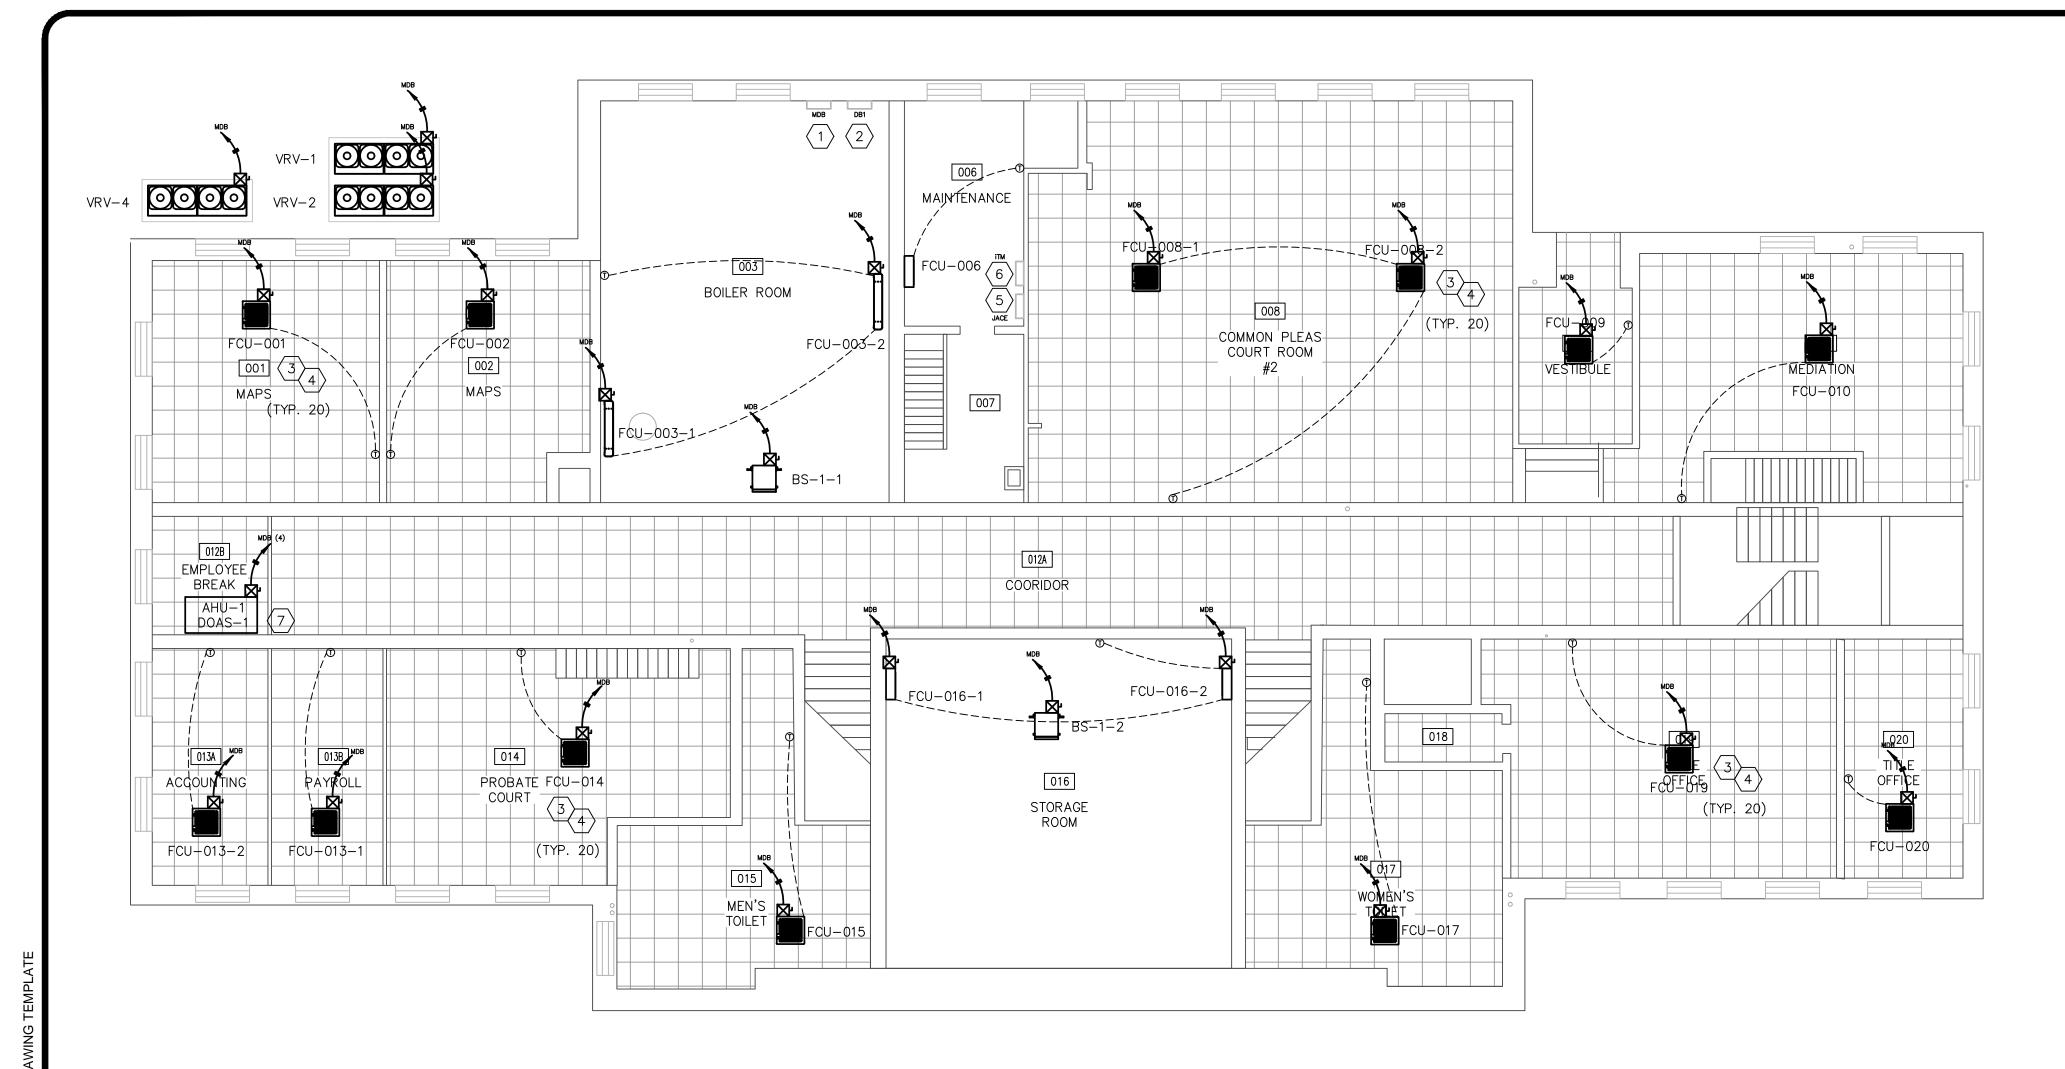



GROUND LEVEL ELECTRICAL WORK

1/8" = 1'-0"

© CODED NOTES:

- 1. ELECTRICAL CONTRACTOR (E.C.) TO PROVIDE AND INSTALL ONE (1) NEW 400A, 84 CIRCUIT, 208/230V, 30 MAIN DISTRIBUTION PANEL REPLACE EXISTING MDB. IN ADDITION TO FEEDING SUB-PANELS DB1 AND DB2, MDB TO FEED BRANCH CIRCUITS FOR VRV-1, VRV-2, VRV-4 AND ALL GROUND FLOOR INDOOR FAN COIL AND BRANCH SELECTOR UNITS. SEE DRAWING E3.0 AND E4.1 FOR ADDITIONAL INFORMATION.
- 2. E.C. TO INSTALL ONE (1) 225A, 54 CIRCUIT, 208/230V, 3Ø SUB-PANEL DB1. DB1 TO FEED BRANCH CIRCUITS FOR ALL FIRST FLOOR INDOOR FAN COIL AND BRANCH SELECTOR UNITS. SEE DRAWING E3.0 AND E4.1 FOR ADDITIONAL INFORMATION.
- 3. E.C. TO PROVIDE NEW 15A, 208/230V, 10 BRANCH CIRCUIT TO EACH INDOOR FAN COIL UNIT AND BRANCH SELECTOR UNIT. INSTALLATION TO INCLUDE BREAKER, CONDUIT, CONDUCTORS AND INDIVIDUAL DISCONNECT FOR EACH CIRCUIT. SEE DRAWING E3.0 AND E4.1 FOR ADDITIONAL INFORMATION.
- 4. TEMPERATURE CONTROL CONTRACTOR (T.C.C.) TO PROVIDE ALL LOW VOLTAGE AND CAT5 COMMUNICATION AND CONTROL WIRE FOR VRV UNITS, BRANCH SELECTOR UNITS, FAN COIL UNITS, ROOM THERMOSTATS, NEW RTU, DOAS UNITS AND BOILER PLANT. CONTRACTOR TO COORDINATE SPECIFIC REQUIREMENTS INCLUDING TYPE/QUANTITY/GAUGE OF WIRING WITH EQUIPMENT MANUFACTURER. INSTALL TO INCLUDEE ALL CONDUIT, RACEWAY AND WIRE MOLD FOR A CLEAN, PROFESSIONAL INSTALLATION.
- 5. T.C.C. TO PROVIDE ONE (1) HONEYWELL JACE-8075 TRIDIUM BASED INTEGRATION DEVICE COMPLETE WITH CONTROL ENCLOSURE, POWER SUPPLY AND INDUSTRIAL NETWORK SWITCH. INSTALLATION TO INCLUDE 5-YEAR TRIDIUM FACTORY SOFWARE MAINTENANCE AGREEMENT AND NIAGARA NETWORK CONNECTION TO EXISTING N4 SUPERVISOR INCLUDING ALL INTEGRATION, 3D FLOOR PLAN, CUSTOM GRAPHICS FOR NEW VRF SYSTEM, DOAS UNITS, RTU AND BOILER
- 6. VRV SYSTEM ITOUCH MANAGER AND BACNET LICENSE TO BE PROVIDED BY M.C. AND INSTALLED/INTEGRATED BY T.C.C. IN APPROXIMATE LOCATION SHOWN IN A DEDICATED ENCLOSURE.
- 7. E.C. TO PROVIDE INDIVIDUAL CIRCUITS FROM MDB TO AHU/DOAS UNIT FOR VRV CONTROLLER, AIR HANDLER, PRE-HEAT AND RE-HEAT COMPONENTS. SEE E3.0 FOR ADDITIONAL INFORMATION.

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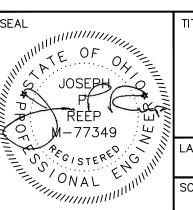
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Ashland County Courthouse HVAC System Upgrades


drawn by: JPR	ORIGIN DATE: 10/12/20	DESIGNED BY: JPR	DATE: 12/31/20
APPROVED BY:	DATE: 01 /21 /21	CLIENT NO.	JOB NO.

DRAWING NAME: 220210 - ELEC.DWG



LOWER LEVEL ELECTRICAL NEW WORK

LAST EDIT DATE: 1/21/21 DRAWING NO. E1.0

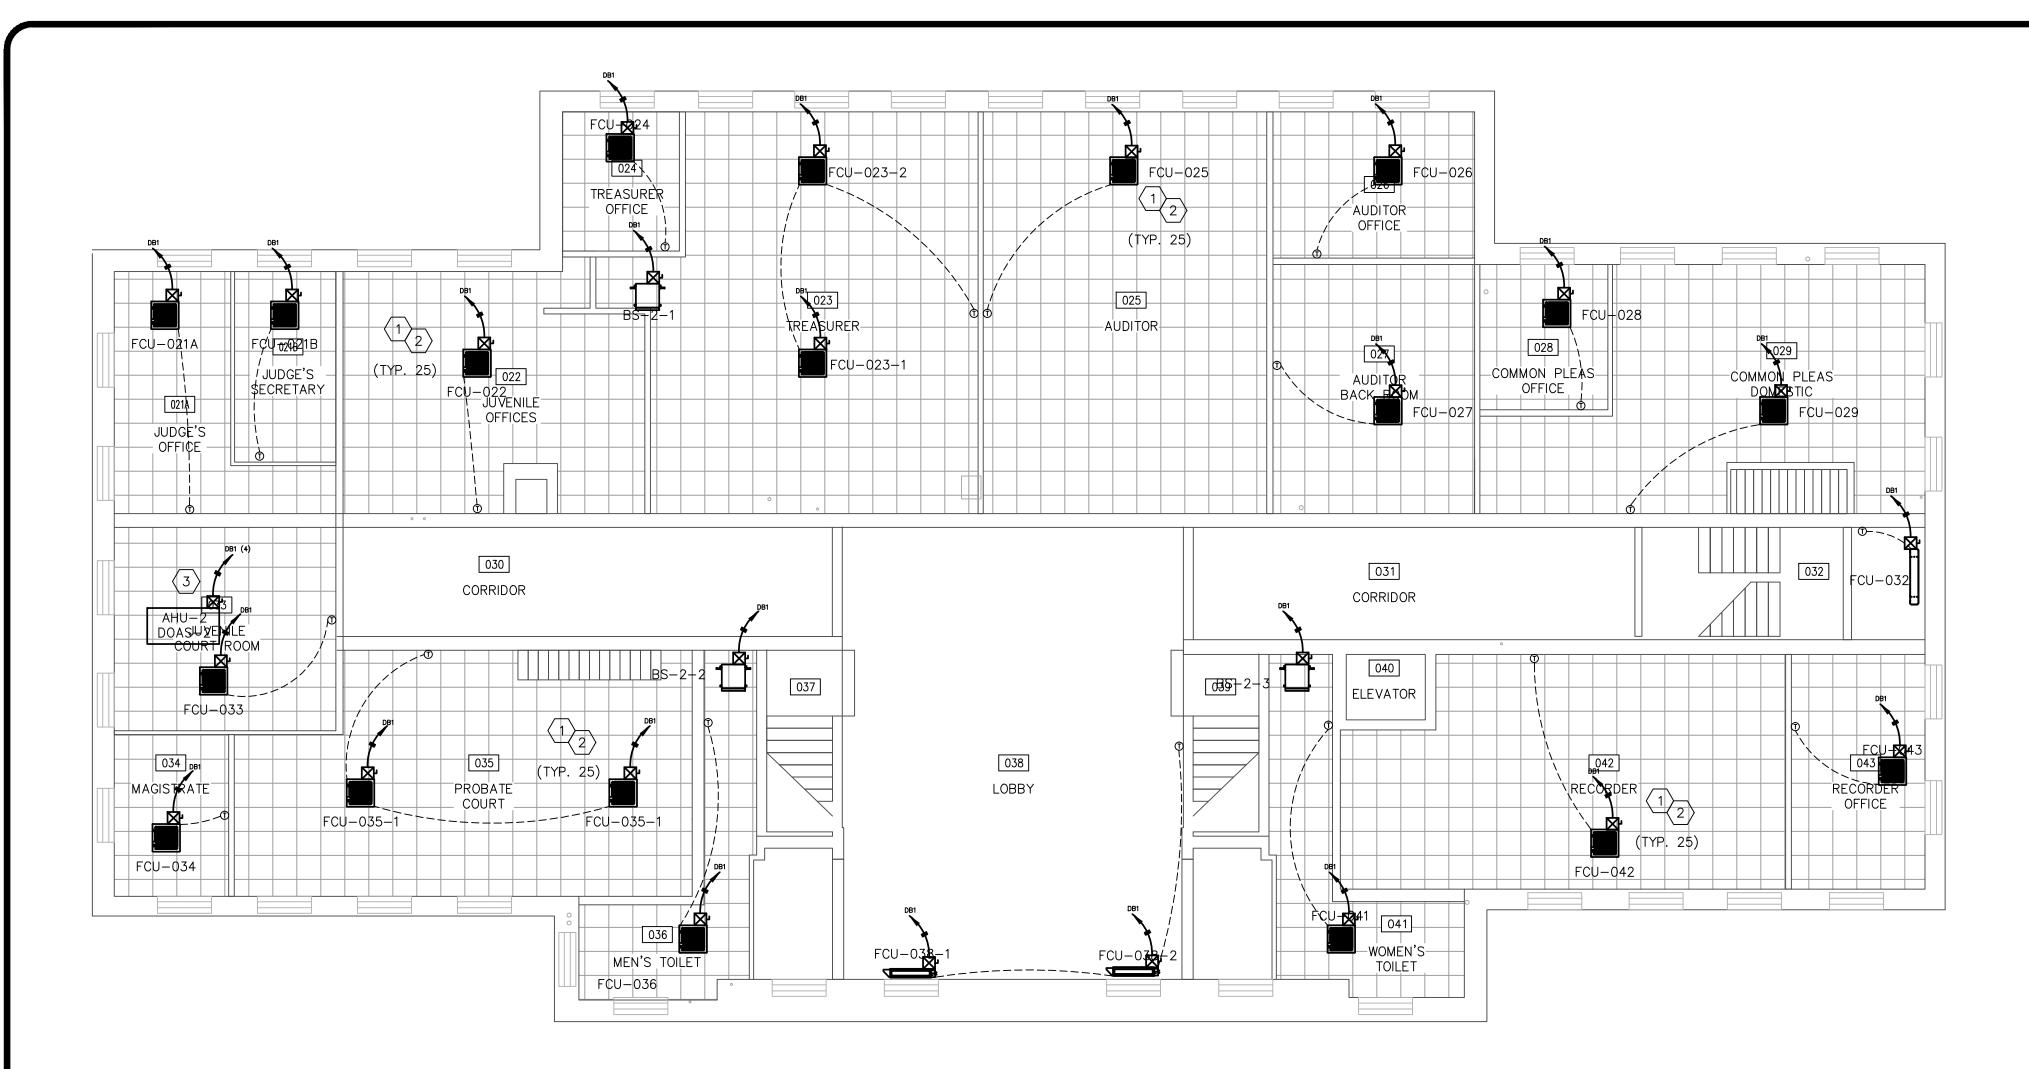



©CODED NOTES:

- 1. E.C. TO PROVIDE NEW 15A, 208/230V, 10 BRANCH CIRCUIT TO EACH INDOOR FAN COIL UNIT AND BRANCH SELECTOR UNIT. INSTALLATION TO INCLUDE BREAKER, CONDUIT, CONDUCTORS AND INDIVIDUAL DISCONNECT FOR EACH CIRCUIT. SEE DRAWING E3.0 AND E4.1 FOR ADDITIONAL INFORMATION.
- 2. TEMPERATURE CONTROL CONTRACTOR (T.C.C.) TO PROVIDE ALL LOW VOLTAGE AND CATS COMMUNICATION AND CONTROL WIRE FOR VRV UNITS, BRANCH SELECTOR UNITS, FAN COIL UNITS, ROOM THERMOSTATS, NEW RTU, DOAS UNITS AND BOILER PLANT. CONTRACTOR TO COORDINATE SPECIFIC REQUIREMENTS INCLUDING TYPE/QUANTITY/GAUGE OF WIRING WITH EQUIPMENT MANUFACTURER. INSTÁLL TO INCLUDEE ALL CONDUIT, RACEWAY AND WIRE MOLD FOR A CLEAN, PROFESSIONAL INSTALLATION.
- 3. E.C. TO PROVIDE INDIVIDUAL CIRCUITS FROM DB1 TO AHU/DOAS UNIT FOR VRV CONTROLLER, AIR HANDLER, PRE-HEAT AND RE-HEAT COMPONENTS. SEE E3.0 FOR ADDITIONAL INFORMATION.

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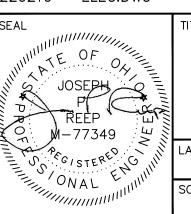


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Ashland County Courthouse HVAC System Upgrades


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DRAWN BY: JPR	ORIGIN DATE: 10/12/20	DESIGNED BY: JPR	DATE: 12/31/20
APPROVED BY: JPR	DATE: 01/21/21	CLIENT NO. ASHOOO	JOB NO. 220210

DRAWING NAME: 220210 - ELEC.DWG



1ST FLOOR ELECTRICAL NEW WORK

LAST EDIT DATE: 1/21/21 DRAWING NO.

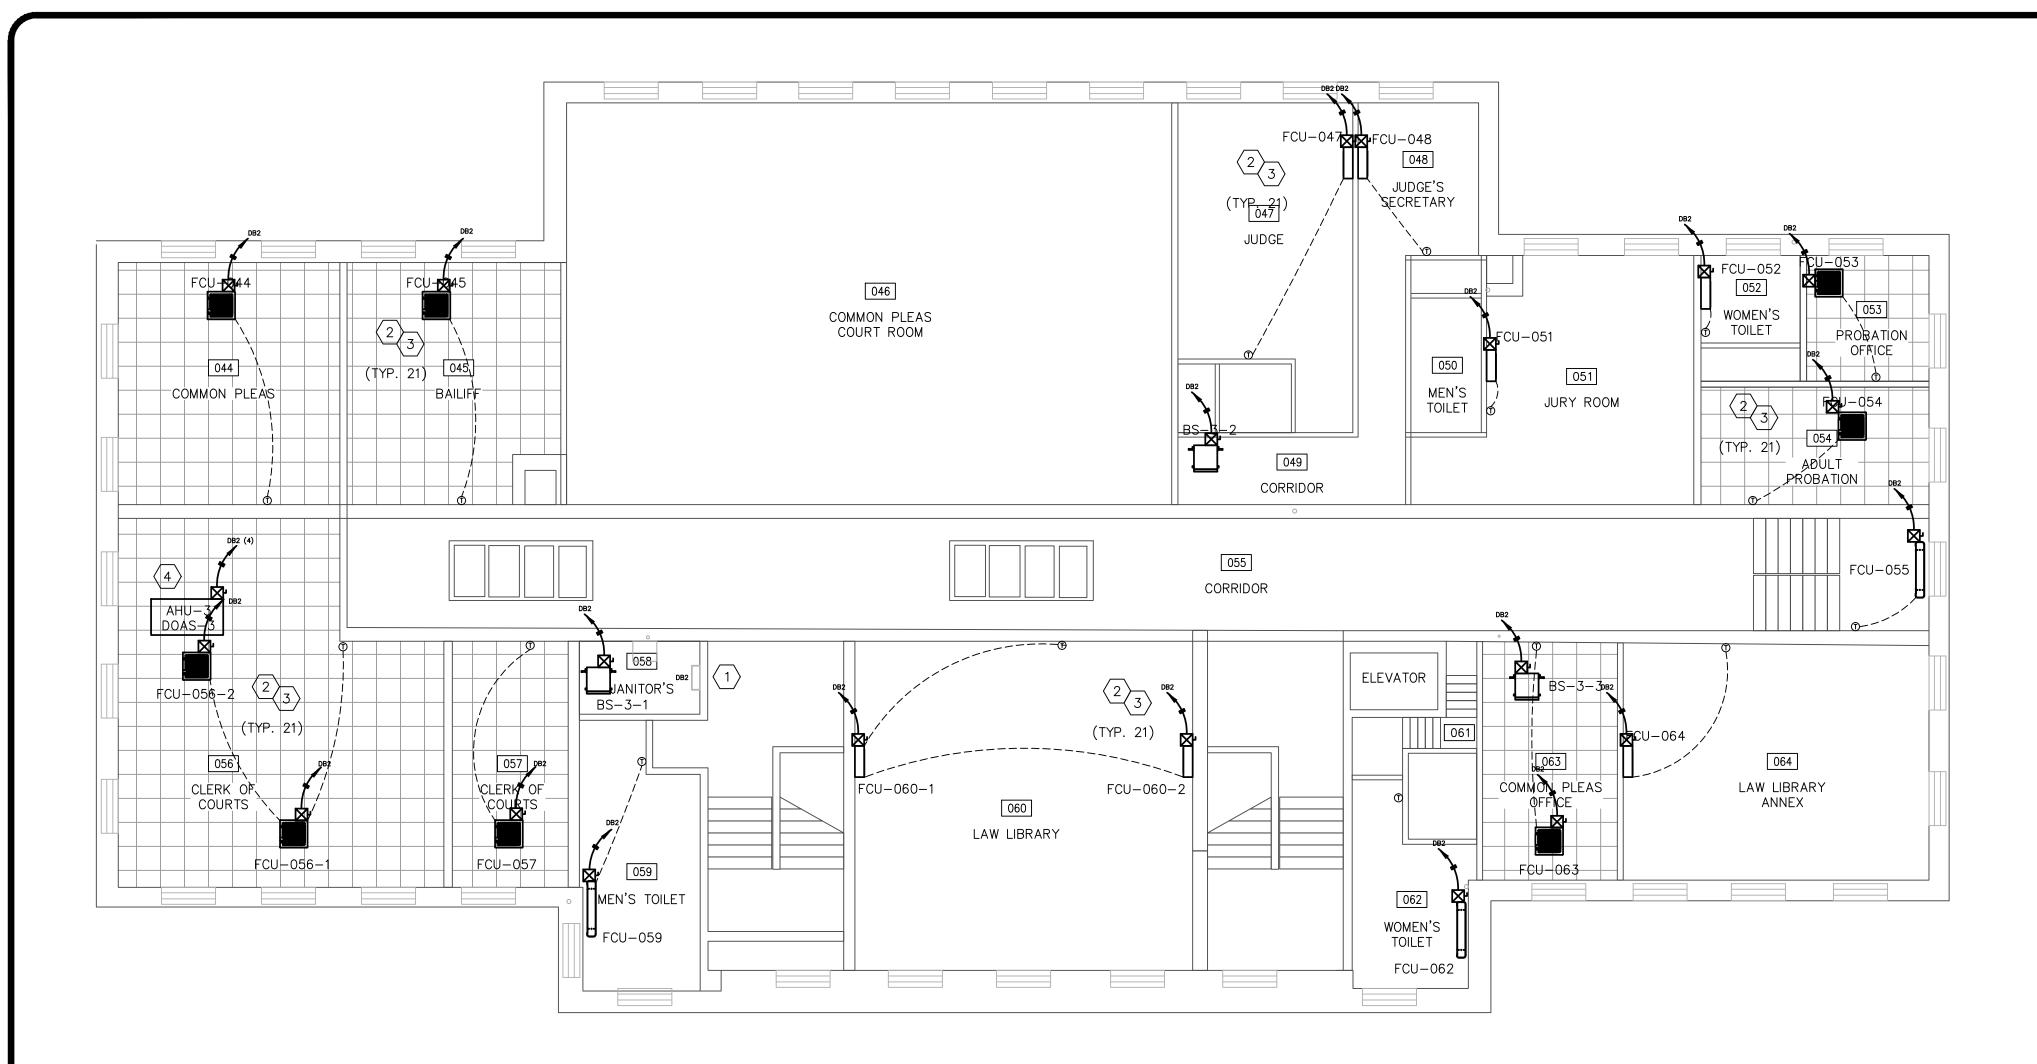

PLAN VIEW 2ND FLOOR ELECTRICAL WORK 1/8" = 1'-0" © CODED NOTES:

- 1. E.C. TO INSTALL ONE (1) 225A, 72 CIRCUIT, 208/230V, 3Ø SUB-PANEL DB1. DB1 TO FEED BRANCH CIRCUITS FOR ALL SECOND FLOOR INDOOR FAN COIL, BRANCH SELECTOR AND DOAS UNITS, NEW RTU AND VRV-3. SEE DRAWING E3.0 AND E4.1 FOR ADDITIONAL INFORMATION.
- 2. E.C. TO PROVIDE NEW 15A, 208/230V, 10 BRANCH CIRCUIT TO EACH INDOOR FAN COIL UNIT AND BRANCH SELECTOR UNIT. INSTALLATION TO INCLUDE BREAKER, CONDUIT, CONDUCTORS AND INDIVIDUAL DISCONNECT FOR EACH CIRCUIT. SEE DRAWING E3.0 AND E4.1 FOR ADDITIONAL INFORMATION.
- 3. TEMPERATURE CONTROL CONTRACTOR (T.C.C.) TO PROVIDE ALL LOW VOLTAGE AND CATS COMMUNICATION AND CONTROL WIRE FOR VRV UNITS, BRANCH SELECTOR UNITS, FAN COIL UNITS, ROOM THERMOSTATS, NEW RTU, DOAS UNITS AND BOILER PLANT. CONTRACTOR TO COORDINATE SPECIFIC REQUIREMENTS INCLUDING TYPE/QUANTITY/GAUGE OF WIRING WITH EQUIPMENT MANUFACTURER. INSTÁLL TO INCLUDEE ALL CONDUIT, RACEWAY AND WIRE MOLD FOR A CLEAN, PROFESSIONAL INSTALLATION.
- 4. E.C. TO PROVIDE INDIVIDUAL CIRCUITS FROM DB2 TO AHU/DOAS UNIT FOR VRV CONTROLLER, AIR HANDLER, PRE-HEAT AND RE-HEAT COMPONENTS. SEE E3.0 FOR ADDITIONAL INFORMATION.

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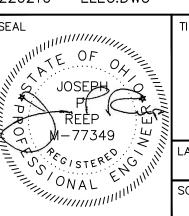


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Ashland County Courthouse HVAC System Upgrades


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APPROVED BY: JPR	DATE: 01/21/21	CLIENT NO.	JOB NO.

DRAWING NAME: 220210 - ELEC.DWG



2ND FLOOR ELECTRICAL NEW WORK

LAST EDIT DATE: 1/21/21 DRAWING NO. E1.2

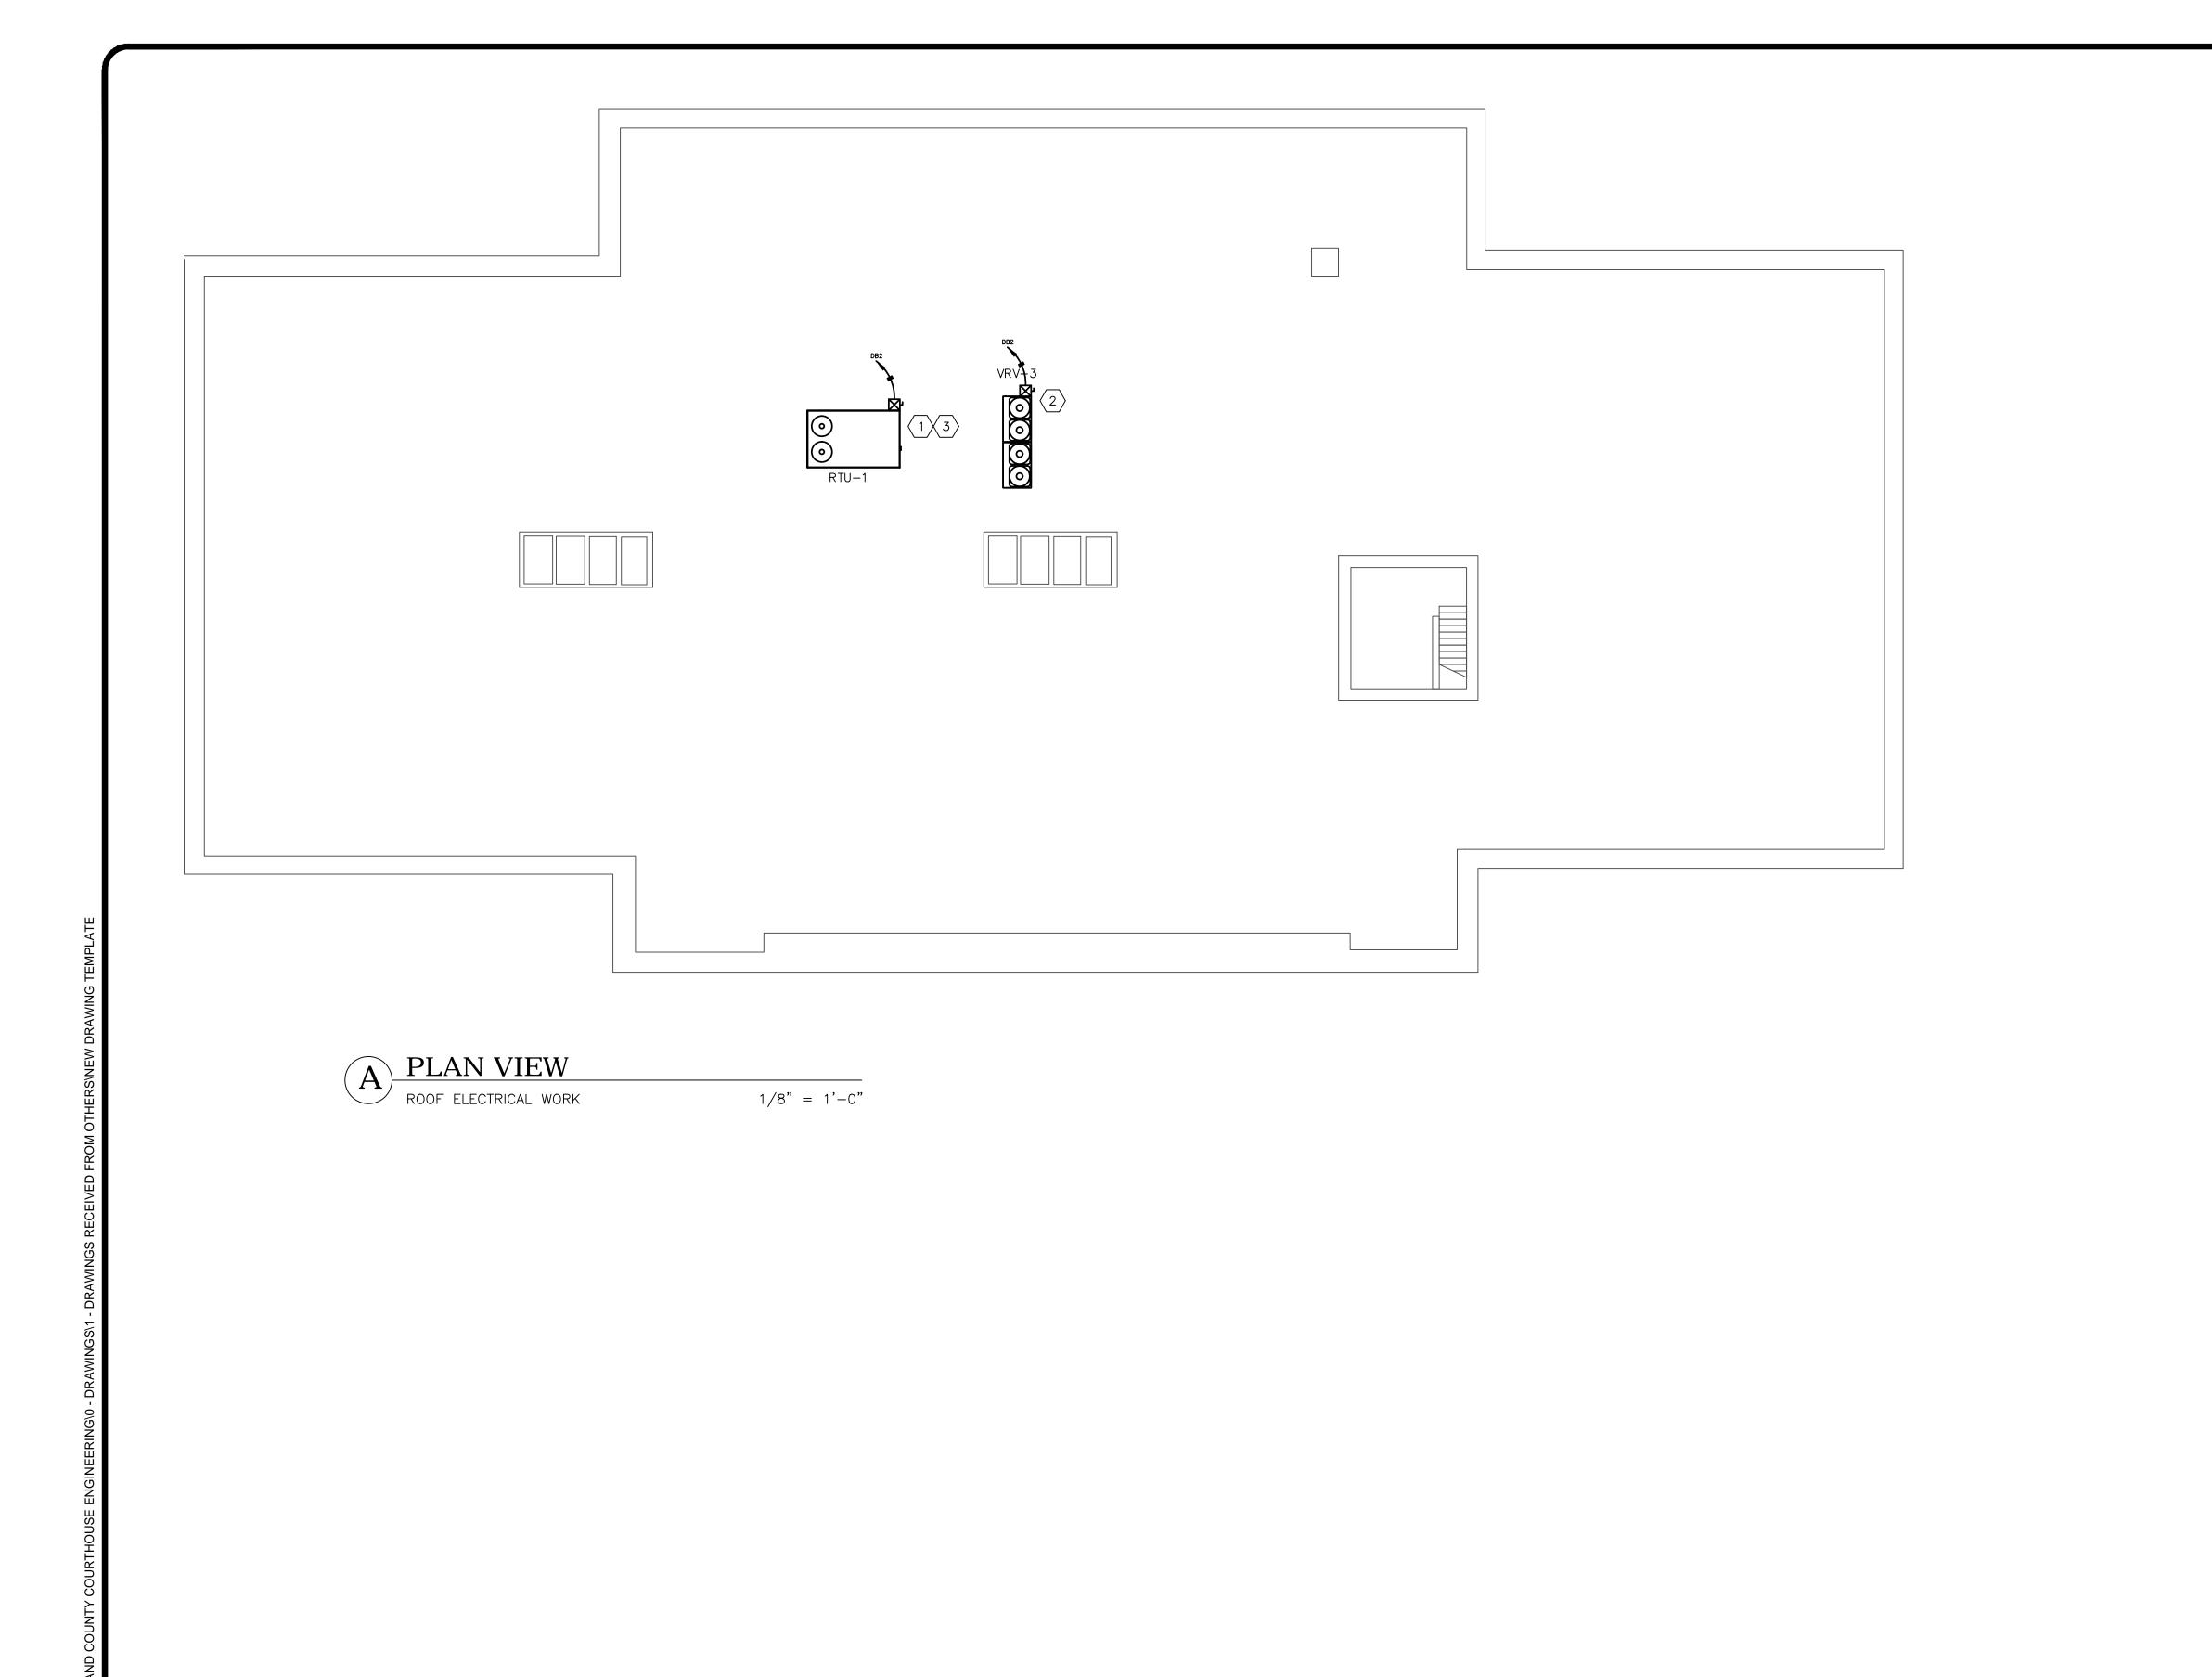

©CODED NOTES:

- 1. ELECTRICAL CONTRACTOR (E.C.) TO PROVIDE NEW 60A, 208/230V, 30 BRANCH CIRCUIT TO NÈW 10-TON ROOFTOP UNIT. INSTALLATION TO INCLUDE BREAKER, CONDUIT, CONDUCTORS AND INDIVIDUAL DISCONNECT FOR EACH CIRCUIT. SEE DRAWING E3.0 AND E4.1 FOR ADDITIONAL INFORMATION.
- 2. E.C TO PROVIDE NEW 70A, 208/230V, 3Ø BRANCH CIRCUIT TO NEW VRV UNIT. INSTALLATION TO INCLUDE BREAKER, CONDUIT, CONDUCTORS AND INDIVIDUAL DISCONNECT FOR EACH CIRCUIT. SEE DRAWING E3.0 AND E4.1 FOR ADDITIONAL INFORMATION.
- 3. E.C. TO PROVIDE 15A CONVENIENCE RECEPTACLE WITH WEATHERPROOF ENCLOSURE AND COVER.

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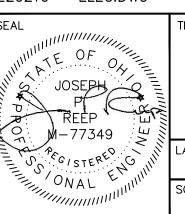
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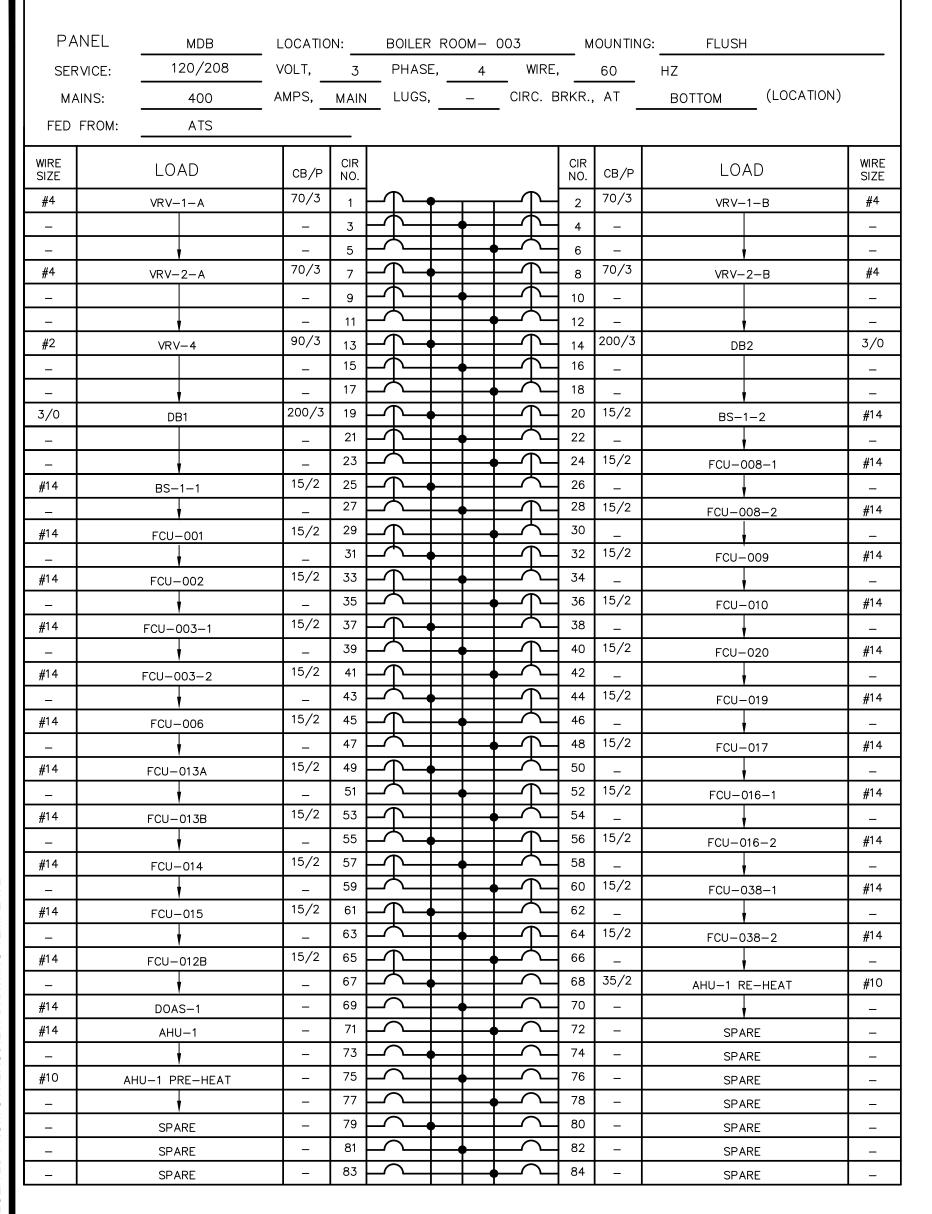
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JPR	10/12/20	JPR	12/31/20
APPROVED BY:	DATE:	CLIENT NO.	JOB NO.
JPR	01 /21 /21	ASHOOO	220210

DRAWING NAME: 220210 - ELEC.DWG



ROOF ELECTRICAL NEW WORK

LAST EDIT DATE: 1/21/21 SCALE: DRAWING NO. E1.3



 PA	.NEL	DB1	LOCATIO	N:	BOILER	ROOM	и — (003	М	OUNTING	G: FLUSH	
SER	NICE:	120/208	-		PHASE				_		-	
 MA	INS:	225	- AMPS,	MAIN	— LUGS,	_	_	– CIRC. B	RKR.,	AT	BOTTOM (LOCATION	1)
	FROM:	MDB			_			•				
WIRE SIZE		LOAD	CB/P	CIR NO.					CIR NO.	CB/P	LOAD	WIRE SIZE
#14		BS-2-2	15/2	1	<u>_</u>			$ \frown$ $-$	2	15/2	BS-2-1	#14
_		V	_	3	}	-			4	_	•	_
#14		FCU-033	15/2	5	4		•	\rightarrow	6	15/2	FCU-021-1	#14
_		•	_	7	{				8	_	•	_
#14		FCU-034	15/2	9	4	-			10	15/2	FCU-021-1	#14
_		V	_	11	$\left\{ -\right\}$		<u></u>	\	12	_		_
#14		FCU-035-1	15/2	13	{			}	14	15/2	FCU-022	#14
_		V	_	15	$\left\{ - \right\}$	—		}	16	_		_
#14		FCU-035-2	15/2	17	4		<u> </u>	}	18	15/2	FCU-024	#14
_		V	_	19	$\left\{ \right.$			}	20	_		_
#14		FCU-036	15/2	21	4	-		}	22	15/2	FCU-023-1	#14
_		↓	_	23	$\left\{ \right.$		<u> </u>	}	24	_	•	_
#14		BS-2-3	15/2	25	{			}	26	15/2	FCU-023-2	#14
_		•	_	27		—			28	_	•	_
#14		FCU-041	15/2	29	Δ		_	- $ -$	30	15/2	FCU-025	#14
_		<u> </u>		31	\sim			_	32	-	•	_
#14		FCU-042	15/2	33	-	•		$ \bigcirc$	34	15/2	FCU-026	#14
_		<u> </u>		35	\sim		_	-	36		•	_
#14		FCU-043	15/2	37	-			- $ -$	38	15/2	FCU-027	#14
_		<u> </u>	_	39	$\langle \ $	•		-	40	-	▼	_
#14		FCU-032	15/2	41			_	- $ -$	42	15/2	FCU-028	#14
_		V	_	43					44	-		_
#14		DOAS-2	15/1	45		•		-	46	15/2	FCU-029	#14
#14		AHU-2	15/2	47			_		48	_		_
_		V	_	49				$\overline{-}$	50	65/2	AHU-2 RE-HEAT	#6
#6	AH	U-2 PRE-HEAT	65/2	51		•			52	_		_
_		•	_	53			_		54	-	SPARE	_

PANEL	DB2	_ LOCATION:		JANITOR	JANITOR'S - 058		MOUNTING:		G: FLUSH		
SERVICE:	120/208	VOLT, _	3	PHASE,	4	WIRE,	, <u> </u>	60	HZ		
MAINS:	225	AMPS,	MAIN	LUGS,	_	CIRC. E	3RKR.	, AT _	воттом	(LOCATION)	j
FED FROM:	MDB					•		_		_	
MIRE SIZE	LOAD	CB/P	CIR NO.				CIR NO.	CB/P	LOA	4D	WII SI:
#4	VRV-3-A	70/3	1	└ ↑		<u> </u>	2	70/3	VRV-3	————— 3-В	#
_			3		\Rightarrow	\bot	4	_			
_			5		\Rightarrow		6	_	i 🗼		+-
#14	BS-3-2	15/2	7		##		8	15/2	BS-3	 5—1	#1
_			9		##		10	_			 " -
#14	FCU-047	15/2	11		\Rightarrow		12	15/2	FCU-(044	#1
_			13		\pm		14	_			 " -
#14	FCU-048	15/2	15		\Rightarrow	一 个	16	15/2	FCU-(045	#1
_	100 0.0	- -	17		$\Rightarrow \Rightarrow$		18	_		310	
#14	FCU-051	15/2	19		##		20	15/2	FCU-0	 56–1	#1
_	100 001		21		\downarrow		22	_	, 55	30 1	- "
#14	FCU-052	15/2	23		\bot		24	15/2	FCU-05	 56-2	#1
_	100 002		25		##		26	_		<u> </u>	 "
#14	FCU-054	15/2	27		#		28	15/2	FCU-(057	#
_		_	29				30	<u> </u>	1	30,	<u> </u>
#14	BS-3-3	15/2	31		##		32	15/2	FCU-(059	#
_			33		\Rightarrow		34	_	i 🗼		
#14	FCU-060-1	15/2	35		#		36	15/2	FCU-(065	#
_			37		##		38		i		<u> </u>
#14	FCU-060-2	15/2	39		\Rightarrow	一 个	40	60/3	RTU-	 _1	#
_			41		#	一个一	42	_		•	
#14	FCU-062	15/2	43		\bot		44	_	i		\top
_			45		\Rightarrow		46	15/1	DOAS		#
#14	FCU-063	15/2	47		\Rightarrow		48	15/2	AHU-		#
_			49		##		50	_	i		
#14	FCU-064	15/2	51		\Rightarrow	$- \wedge$	52	35/2	AHU-3 PR	E-HEAT	#
_			53		#		54	_	i 🗼		
_	SPARE	_	55		$\Rightarrow \Rightarrow$		56	35/2	AHU-3 RE	E-HEAT	#
_	SPARE		57		\Rightarrow		58	_	i		<u> </u>
_	SPARE		59		\Rightarrow		60	_	SPAF	 RF	Τ.
_	SPARE		61		##		62	_	SPAF		† .
_	SPARE		63		\downarrow		64	_	SPAF		.
_	SPARE		65		#		66	_	SPAF		1.
_	SPARE		67		##		68	_	SPAF		<u> </u>
_	SPARE		69				70		SPAF		
	SPARE	- -	71		+	$\overline{}$	72	\vdash	SPAF		+


ELECTRICAL SPECIFICATIONS:

- 1. THE REQUIREMENTS AS SET FORTH UNDER GENERAL CONDITIONS, INSTRUCTIONS TO BIDDERS AND GENERAL REQUIREMENTS ARE A PART OF THIS CONTRACT.
- 2. BIDS SHALL BE BASED ON A COMPLETE/FULL SET OF DRAWINGS. CONTRACTOR IS RESPONSIBLE FOR COORDINATION OF WORK WITH WORK PERFORMED BY OTHER TRADES.
- 3. CONTRACTOR SHALL VISIT SITE PRIOR TO BIDDING. BIDS SHALL SERVE AS EVIDENCE OF KNOWLEDGE OF EXISTING CONDITIONS. FIELD VERIFY ALL EXISTING ELECTRICAL LOCATIONS, CONDITIONS ETC. FAILURE TO VISIT THE SITE SHALL NOT RELIEVE THE CONTRACTOR FROM ANY RESPONSIBILITY IN THE PERFORMANCE OF THE ELECTRICAL WORK. BEGINNING OF WORK INDICATES ACCEPTANCE OF EXISTING CONDITIONS.
- 4. FURNISH ALL LABOR, MATERIALS, TESTING, EQUIPMENT, INCIDENTALS AND TOOLS TO PERFORM ELECTRICAL WORK SHOWN, NOTED OR SCHEDULED FOR A COMPLETE AND FINISHED INSTALLATION. MATERIALS, PRODUCTS AND EQUIPMENT, INCLUDING ALL COMPONENTS THEREOF, SHALL BE NEW AND AS SUCH APPEAR ON THE UNDERWRITERS LABORATORIES LIST OF APPROVED ITEMS AND SHALL BE SIZED IN CONFORMITY WITH REQUIREMENTS OF THE LATEST EDITION OF THE NATIONAL ELECTRICAL CODE AND OTHER APPLICABLE CODES, WHICHEVER ARE MORE STRINGENT.

- 5. ALL WORK IS TO BE IN ACCORDANCE WITH THE LATEST EDITION OF THE NEC AND ALL APPLICABLE FEDERAL, STATE AND LOCAL CODES.
- 6. SECURE AND PAY FOR ALL REQUIRED PERMITS. FEES. ASSESMENTS AND INSPECTION CERTIFICATES THAT RELATE TO THE ELECTRICAL CONTRACT. FURNISH APPROVED CERTIFICATE OF FINAL INSPECTION, AND TURN OVER TO OWNER AT COMPLETION OF PROJECT.
- 7. THESE ELECTRICAL PLANS ARE DIAGRAMMATIC, NOT SHOWING EVERY ITEM IN EXACT LOCATION OR DETAIL. MEASUREMENTS AND LOCATIONS MUST BE FIELD-VERIFIED AND COORDINATED WITH ARCHITECTURAL, PLUMBING, HVAC, FIRE PROTECTION, STRUCTURAL AND OTHER BUILDING DRAWINGS.
- 8. CONDUIT SHALL BE STANDARD STEEL RIGID, IMC OR EMT (THIN WALL) ACCORDING TO LOCAL CODE REQUIREMENTS. CONDUIT SHALL BE CONCEALED IN FINISHED AREAS, EXCEPT AS OTHERWISE APPROVED.
- 9. WIRE SHALL BE SINGLE CONDUCTOR COPPER WITH 600 VOLT INSULATION. MINIMUM WIRE SIZE SHALL BE #12 AWG, ALL WIRE AND CABLE SHALL BE NEW AND SHALL BE BROUGHT TO THE SITE IN UNBROKEN PACKAGES. ALL WIRING OF ANY TYPE SHALL BE IN CONDUIT. NO STRANDED WIRE ALLOWED FOR #10 AND #12 AWG SIZES. INCREASE CONDUCTOR BY ONE SIZE FOR EVERY 150' INCREMENT OF DISTANCE FROM THE PANEL BOARD FOR 120 VOLT CIRCUITS. GENERAL WIRING SHALL BE THW OR THHN. ALUMINUM CONDUCTORS ARE ONLY PERMITTED FOR PANEL FEEDERS AND SERVICE ENTRANCE CONDUCTORS. ALUMINUM CONDUCTORS ARE NOT PERMITTED FOR BRANCH CIRCUIT WIRING. TYPE NM WIRING IS APPROVED FOR CONCEALED BRANCH CIRCUIT WIRING.

- 10. FURNISH AND INSTALL A COMPLETE WIRED GROUNDING SYSTEM FOR ELECTRICAL EQUIPMENT AND CIRCUITS AS SHOWN ON THE DRAWINGS AND REQUIRED PER N.E.C. ARTICLE 250. ALL GROUNDING CONDUCTORS SHALL BE GREEN, WHERE EXPOSED IN PANEL, OUTLETS, BOXES, ETC.
- 11. PROVIDE BRANCH CIRCUIT PANELS WHICH SHALL BE OF THE BOLTED CIRCUIT BREAKER TYPE WITH SOLID COPPER BUSSING FULL SIZED NEUTRAL, 25% GROUND BUSSING, OVERALL HINGED/LOCKABLE DOOR, AND TYPEWRITTEN DIRECTORY INSIDE DOOR ALL SERVICE ENTRANCE EQUIPMENT SHALL BEAR THE MANUFACTURER'S LABEL WHICH SHALL STATE THAT THE EQUIPMENT IS RATED FOR SERVICE ENTRANCE APPLICATION IN ACCORDANCE WITH N.E.C. #230-70. LOAD BALANCE ALL ELECTRICAL PHASES AT PANEL. TWO POLE BREAKERS SHALL BE COMMON TRIP TYPE. SQUARE D OR EQUAL BY SIEMENS, EATON, OR GENERAL ELECTRIC. NEMA 3R ENCLOSURE AS NOTED. PROVIDE ARC FAULT LABELING PER NEC. LOAD CENTER TYPE PANELS ARE APPROVED.
- 12. ALL ELECTRIC WORK SHALL BE INSTALLED SO AS TO BE READILY ACCESSIBLE FOR OPERATING, SERVICING, MAINTAINING AND REPAIRING. HANGERS SHALL INCLUDE ALL MISCELLANEOUS STEEL SUCH AS CHANNELS, RODS, ETC., NECESSARY FOR THE INSTALLATION OF WORK AND SHALL BE FASTENED TO BUILDING STEEL, CONCRETE OR MASONRY, BUT NOT PIPING OR DUĆTWORK. ALL CONDUIT SHALL BE CONCEALED WHEREVER POSSIBLE. EXPOSED CONDUITS SHALL BE IN STRAIGHT LINES PARALLEL WITH OR AT RIGHT ANGLES TO COLUMN LINES OR BEAMS AND SEPARATED AT LEAST 3 INCHES FROM WATER LINES WHEREVER THEY RUN ALONGSIDE OR ACROSS SUCH LINES. ALL CONDUCTORS SHALL BE IN CONDUIT, DUCTS OR OTHER CODE APPROVED RACEWAYS.

- 13. MATERIALS, EQUIPMENT AND INSTALLATION SHALL BE GUARANTEED FOR A PERIOD OF ONE (1) YEAR FROM DATE OF ACCEPTANCE. DEFECTS APPEARRING IN THAT PERIOD SHALL BE CORRECTED AT THE ELECTRICAL CONTRACTOR'S EXPENSE. FOR THE SAME PERIOD, ELECTRICAL CONTRACTOR SHALL BE RESPONSIBLE FOR ANY DAMAGE TO PREMISES CAUSED BY DEFECTS IN WORKMANSHIP OR IN THE WORK OR EQUIPMENT FURNISHED AND/OR INSTALLED BY THE ELECTRICAL CONTRACTOR.
- 14.IT IS THE INTENT THAT THE FOREGOING WORK SHALL BE COMPLETE IN EVERY RESPECT AND THAT ANY MATERIAL OR WORK NOT SPECIFICALLY MENTIONED OR SHOWN ON THE DRAWINGS, BUT NECESSARY TO FULLY COMPLETE THE WORK SHALL BE FURNISHED.

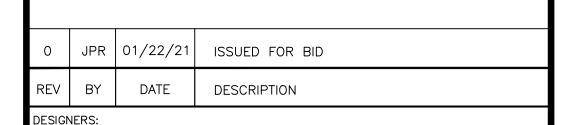



ASHLAND COMFORT CONTROL HEATING-AIR CONDITIONING-FIREPLACES-PLUMBING 805 E. MAIN STREET - ASHLAND, OH

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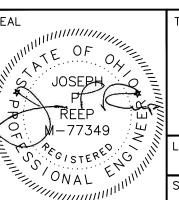
PROJECT



Ashland County Courthouse HVAC System Upgrades

DRAWN BY:	ORIGIN DATE:	DESIGNED BY:	DATE:
JPR	10/12/20	JPR	12/31/20
APPROVED BY:	DATE:	CLIENT NO.	JOB NO.
JPR	01/21/21	ASHOOO	220210


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ELECTRICAL PANEL SCHEDULE AND **SPECIFICATIONS**

1/21/21

LAST EDIT DATE: DRAWING NO. E3.0



X CODED NOTES:

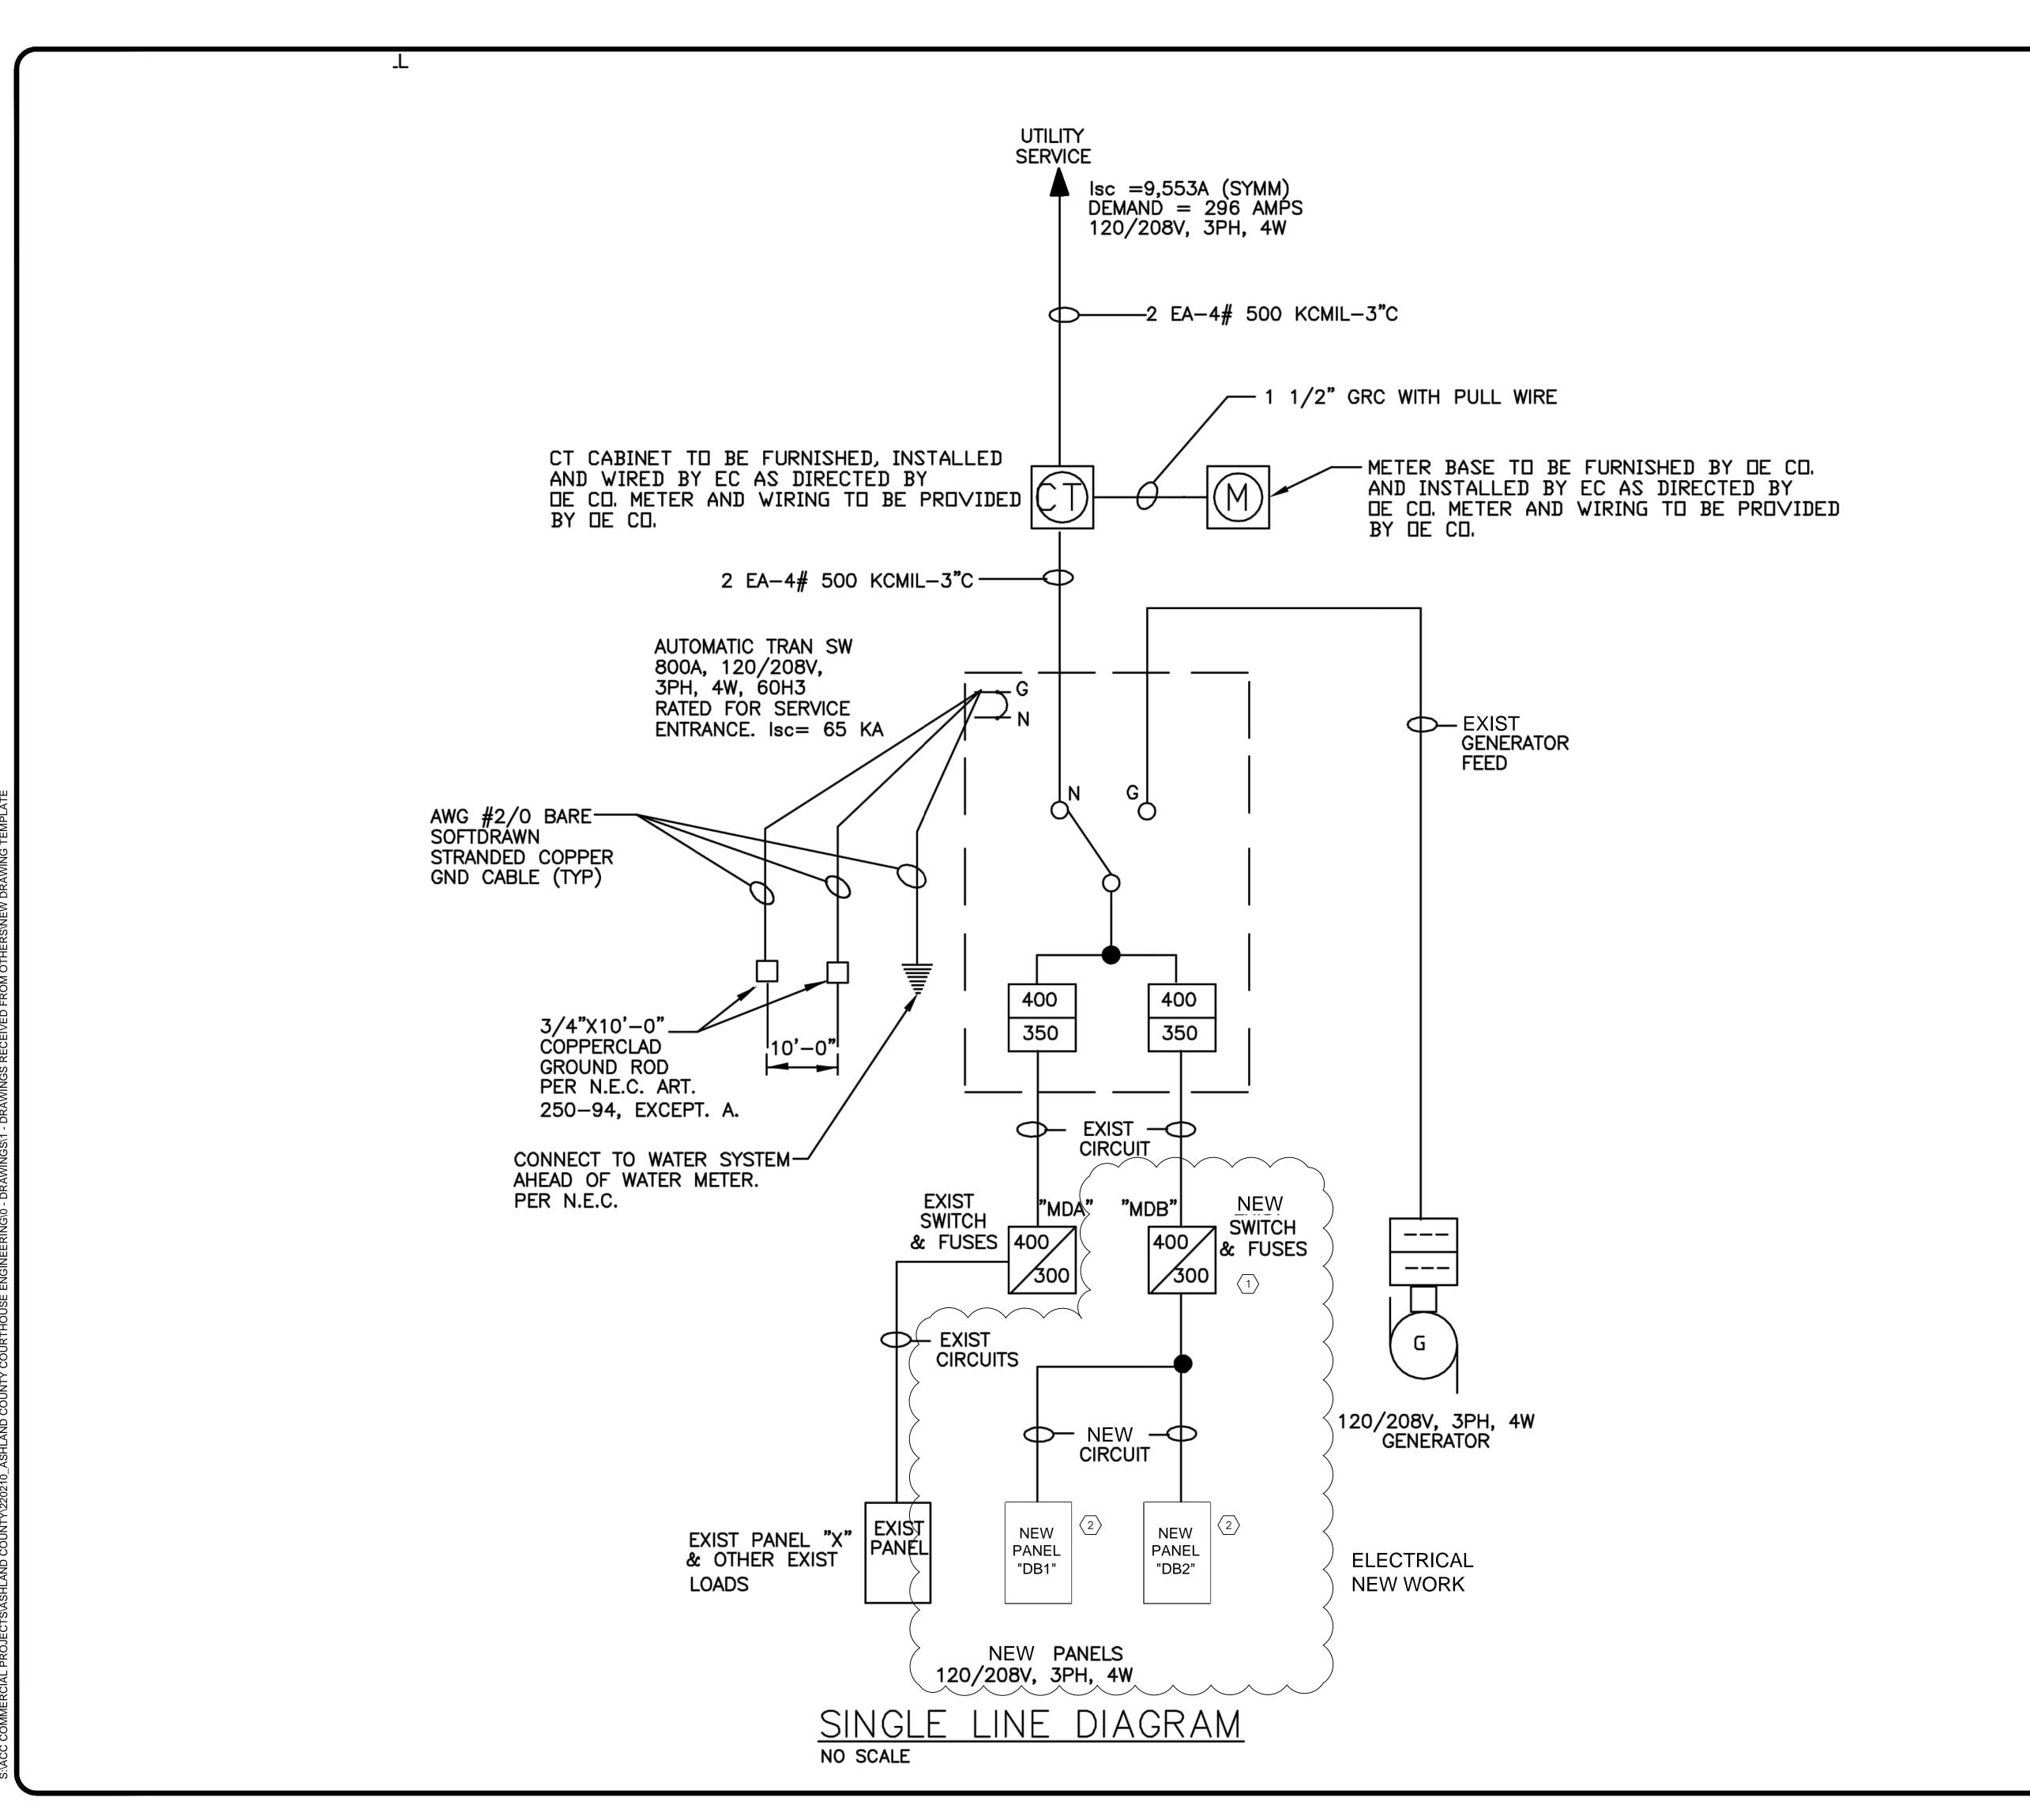- ELECTRICAL CONTRACTOR (E.C.) TO PROVIDE AND INSTALL ONE NEW 400A, 84 CIRCUIT, 208/230V, 30 MAIN DISTRIBUTION PANEL REPLACE EXISTING MDB. IN ADDITION TO FEEDING SUB-PANELS DB1 AND DB2, MDB TO FEED BRANCH CIRCUITS FOR VRV-1, VRV-2, VRV-4 AND ALL GROUND FLOOR INDOOR FAN COIL AND BRANCH SELECTOR UNITS.
- 2. E.C. TO INSTALL TWO (2) 225A, 54 CIRCUIT, 208/230V, 30 SUB-PANELS DB1 & DB2. DB1 & DB2 TO FEED BRANCH CIRCUITS FOR REMAINING VRV, DOAS, INDOOR FAN COIL AND BRANCH SELECTOR UNITS. EXISTING CIRCUITRY SERVING WINDOW AIR CONDITIONERS TO BE DISCONNECTED AND ABANDONED IN PLACE.
- 3. E.C. TO PROVIDE 15A CONVENIENCE RECEPTACLE WITH WEATHERPROOF ENCLOSURE AND COVER.

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ASHLAND COMFORT CONTROL HEATING-AIR CONDITIONING-FIREPLACES-FLUBBING

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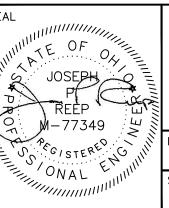


Ashland County Courthouse HVAC System Upgrades

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JPR	01/21/21	ASHOOO	220210

DRAWING NAME:

220210 - ELEC.DWG



ELECTRICAL SINGLE LINE DIAGRAM

LAST EDIT DATE: 1/21/21 SCALE: DRAWING NO. E4.0

